

- 1. EXISTING UTILITIES AND EXISTING IMPROVEMENTS MAY BE SHOWN AT APPROXIMATED LOCATIONS DUE TO THE AVAILABLE RECORD INFORMATION AT THE TIME OF PLAN PREPARATION. OTHER UTILITY LINES MAY EXIST. IT SHALL BE THE RESPONSIBILITY OF THE CONTRACTOR TO FIELD VERIFY ALL EXISTING UTILITIES BY POTHOLING OR LOCATING SERVICES "811" IF FOUND NECESSARY.
- 2. THE CONTRACTOR SHALL NOTIFY ALL CORRESPONDING UTILITY COMPANIES AND CALL "811" AT LEAST 48 HOURS BEFORE THE COMMENCEMENT OF ANY WORK WHICH MAY REQUIRE UTILITY VERIFICATION. ADDITIONALLY, THE CONTRACTOR WILL SUPPLY SOUTHERN CALIFORNIA GAS COMPANY WITH A CONSTRUCTION SCHEDULE AND NOTIFY OF ANY PRE-CONSTRUCTION MEETINGS.
- 3. THE EXISTENCE AND LOCATION OF ANY UNDERGROUND UTILITY OR SUBSTRUCTURE SHOWN ON THESE PLANS WERE OBTAINED BY A SEARCH OF AVAILABLE RECORDS. NO CERTIFICATIONS IS MADE AS TO THE ACCURACY OR THOROUGHNESS OF THESE RECORDS. APPROVAL OF THESE PLANS BY THE CITY OF LEMOORE DOES NOT CONSTITUTE A REPRESENTATION OF THE ACCURACY OR COMPLETENESS OF LOCATION OR THE EXISTENCE OR NONEXISTENCE OF ANY UNDERGROUND UTILITY OR SUBSTRUCTURE WITHIN THE LIMITS OF THE PROJECT.
- 4 IT IS THE RESPONSIBILITY OF THE CONTRACTOR TO REVIEW THE FULL SET OF PLANS FOR ANY DISCREPANCIES AND OMISSIONS PRIOR TO THE COMMENCEMENT OF WORK. IF ANY DISCREPANCIES BETWEEN THESE PLANS AND THE FIELD ARE IDENTIFIED, THE CONTRACTOR SHALL NOTIFY THE ENGINEER. THE CONTRACTOR SHALL BE RESPONSIBLE FOR ANY WORK NOT IN CONFORMANCE WITH THE PLANS OR IN CONFLICT WITH ANY CODE.
- 5. AN APPROVED SET OF PLANS MUST BE AVAILABLE ON THE JOB SITE AT ALL TIMES.
- 6. THE CONTRACTOR SHALL POSSESS THE CLASS (OR CLASSES) OF LICENSE AS SPECIFIED IN THE "NOTICE TO BIDDERS."
- 7. ALL WORK SHALL BE PERFORMED IN CONFORMANCE WITH THE PROVISIONS IN THE CALTRANS STANDARD SPECIFICATIONS AND PLANS DATED 2024, ALONG WITH THE CITY OF LEMOORE STANDARD DRAWINGS.
- 8. THE CONTRACTOR SHALL BE RESPONSIBLE FOR PROVIDING ALL MATERIALS, FABRICATIONS, EQUIPMENT, APPLIANCES, TRANSPORTATION, SERVICES, AND LABOR NECESSARY FOR THE CONSTRUCTION, ERECTION, AND INSTALLATION OF ALL WORK INDICATED ON THESE DRAWINGS AND/OR OUTLINED IN EACH SECTION OF THE SPECIFICATIONS.
- 9. FOR THE DURATION OF THE WORK, THE CONTRACTOR SHALL PROVIDE, INSTALL AND MAINTAIN AS MAY BE REQUIRED, ALL NECESSARY BARRICADES AND RAILINGS, LIGHTS, WARNING SIGNS, AND SIGNALS, AND SHALL TAKE ALL OTHER PRECAUTIONS AS MAY BE REQUIRED TO SAFEGUARD PERSONS, THE JOB SITE AND ADJOINING PROPERTY, AGAINST INJURIES AND DAMAGE OF ANY NATURE.
- 10. THE CONTRACTOR AND EACH SUBCONTRACTOR SHALL GIVE THEIR PERSONAL ATTENTION TO THE WORK; BE RESPONSIBLE FOR THE LAYOUT AND CORRECTNESS OF THEIR WORK AND COOPERATE WITH EACH OF THE VARIOUS TRADES TO OBTAIN A NEAT FINISHED AND
- 11. THE CONSTRUCTION CONTRACTOR AGREES THAT IN ACCORDANCE WITH GENERALLY ACCEPTED CONSTRUCTION PRACTICES, THE CONSTRUCTION CONTRACTOR WILL BE REQUIRED TO ASSUME SOLE AND COMPLETE RESPONSIBILITY FOR JOB SITE CONDITIONS DURING THE COURSE OF CONSTRUCTION OF THE PROJECT AT ALL TIMES AND IS NOT LIMITED TO NORMAL WORKING HOURS. THIS INCLUDES THE SUPERVISION AND SAFETY OF ALL PERSONS AND PROPERTY WITHIN THE PROJECT SITE FROM POTENTIAL HAZARDS RESULTING FROM
- ENGINEER, AND THE OFFICERS, DIRECTORS, MEMBERS, PARTNERS, EMPLOYEES, AGENTS, CONSULTANTS AND SUBCONTRACTORS OF EACH AND ANY OF THEM FROM AND AGAINST ALL CLAIMS, COSTS, LOSSES, AND DAMAGES (INCLUDING BUT NOT LIMITED TO ALL FEES AND CHARGES OF ENGINEERS, ARCHITECTS, ATTORNEYS, AND OTHER PROFESSIONALS AND ALL COURT OR ARBITRATION OR OTHER DISPUTE RESOLUTION COSTS) ARISING OUT OF OR RELATING TO THE PERFORMANCE OF THE WORK, PROVIDED THAT ANY SUCH CLAIM, COST, LOSS, OR DAMAGE IS ATTRIBUTABLE TO BODILY INJURY, SICKNESS, DISEASE, OR DEATH, OR TO INJURY TO OR DESTRUCTION OF TANGIBLE PROPERTY (OTHER THAN THE WORK ITSELF), INCLUDING THE LOSS OF USE RESULTING THEREFROM BUT ONLY TO THE EXTENT CAUSED BY ANY NEGLIGENT ACT OR OMISSION OF CONTRACTOR, ANY SUBCONTRACTOR, ANY SUPPLIER, OR ANY INDIVIDUAL OR ENTITY DIRECTLY OR INDIRECTLY EMPLOYED BY ANY OF THEM TO PERFORM ANY OF THE WORK OR ANYONE FOR WHOSE ACTS ANY OF THEM
- 13. DO NOT SCALE DRAWINGS. IF UNABLE TO LOCATE DIMENSIONS FOR ANY ITEM OF WORK, CONTACT THE ENGINEER FOR DIRECTION
- 14. ALL DAMAGE TO AREAS AND/OR PROPERTY NOT SPECIFICALLY PART OF THE PROJECT SITE CAUSED DURING CONSTRUCTION ACTIVITIES WILL BE THE RESPONSIBILITY OF THE CONTRACTOR TO RETURN TO PRE-CONSTRUCTION CONDITIONS.
- 15. CHANGES TO THE APPROVED DRAWINGS SHALL BE MADE BY ADDENDUM OR A CHANGE ORDER SIGNED BY THE ENGINEER AND APPROVED BY THE PUBLIC WORKS/ENGINEERING OFFICIALS.
- 16. DUST AND DEBRIS CONTROL MEASURES SHALL BE IMPLEMENTED IN ACCORDANCE WITH THE REQUIREMENTS OF THE SAN JOAQUIN VALLEY UNIFIED AIR POLLUTION CONTROL DISTRICT - DISTRICT REGULATION VIII - FUGITIVE DUST RULES. THE CONTRACTOR SHALL PROTECT WORKERS FROM EXPOSURE TO VALLEY FEVER DURING DEMOLITION AND CONSTRUCTION OPERATIONS BY COMPLYING WITH APPLICABLE REGULATIONS, INCLUDING CALIFORNIA LABOR CODE §6709. THIS SHALL INCLUDE PROVIDING ANNUAL VALLEY FEVER TRAINING TO EMPLOYEES AND PRIOR TO ANY SOIL-DISTURBING WORK. TRAINING SHALL COVER TRANSMISSION, RISK FACTORS, SYMPTOMS, PREVENTION METHODS, AND THE USE OF PERSONAL PROTECTIVE EQUIPMENT (PPE). THE CONTRACTOR SHALL IMPLEMENT DUST CONTROL MEASURES AND MONITOR SITE CONDITIONS TO ENSURE THEIR EFFECTIVENESS. WHEN DUST CANNOT BE ADEQUATELY CONTROLLED, THE CONTRACTOR SHALL PROVIDE NIOSH-APPROVED RESPIRATORS OR OTHER APPROPRIATE PPE. SUSPECTED WORK-RELATED CASES SHALL BE PROMPTLY REPORTED IN ACCORDANCE WITH CAL/OSHA REQUIREMENTS.
- 17. IN ORDER TO REDUCE NOISE IMPACTS FROM THE CONSTRUCTION PROJECT, ALL CONSTRUCTION ACTIVITIES SHALL ONLY OCCUR BETWEEN THE HOURS OF 7:00 AM AND 4:30 PM.
- 18. THE CONTRACTOR SHALL PREPARE AND SUBMIT A TEMPORARY TRAFFIC CONTROL PLAN FOR REVIEW AND APPROVAL BY THE CITY AND THE ENGINEER PRIOR TO ANY WORK IN THE STREET RIGHT-OF-WAY. CONSTRUCTION AREA SIGNS FOR TEMPORARY TRAFFIC CONTROL SHALL BE FURNISHED, INSTALLED, MAINTAINED, AND REMOVED WHEN NO LONGER REQUIRED IN CONFORMANCE WITH THE PROVISIONS IN SECTION 12, "TEMPORARY TRAFFIC CONTROL DEVICES," OF THE STANDARD SPECIFICATIONS AND THE SPECIAL PROVISIONS.
- 19. CONTRACTOR SHALL SUBMIT A MONUMENTATION PERPETUATION PLAN TO BE APPROVED BY THE ENGINEER BEFORE COMMENCING
- 20. CONTRACTOR TO PROVIDE TEMPORARY REFLECTIVE MARKERS AND TO PROTECT IN PLACE AFTER INSTALLATION. ANY MARKER THAT IS DAMAGED AND IS NO LONGER REFLECTIVE SHALL BE REMOVED AND REPLACED AT THE CONTRACTOR'S EXPENSE. CONTRACTOR SHALL HAVE THE OPTION OF PLACING TEMPORARY MARKERS IMMEDIATELY AFTER ROADWAY TREATMENT TO AVOID REFLECTIVE MARKER
- 21. CONTRACTOR SHALL ISSUE NOTICE OF WORK TO RESIDENTS 72 HOURS PRIOR TO COMMENCEMENT OF WORK. NOTICE SHALL BE SUBMITTED FOR APPROVAL PRIOR TO DISBURSEMENT
- 22. CONTRACTOR SHALL COORDINATE WORK SCHEDULE WITH ANY PUBLIC AGENCY THAT MAY BE IMPACTED SUCH AS REFUSE, SCHOOL DISTRICT, LOCAL TRANSIT AUTHORITY, POLICE DEPARTMENT, FIRE DEPARTMENT, AND OTHER PUBLIC SERVICES.
- 23. CONTRACTOR SHALL BE RESPONSIBLE FOR PLACING NO PARKING SIGNAGE 72 HOURS PRIOR TO WORK AND THE REMOVAL OF PARKED VEHICLES WITHIN PROJECT LIMITS.

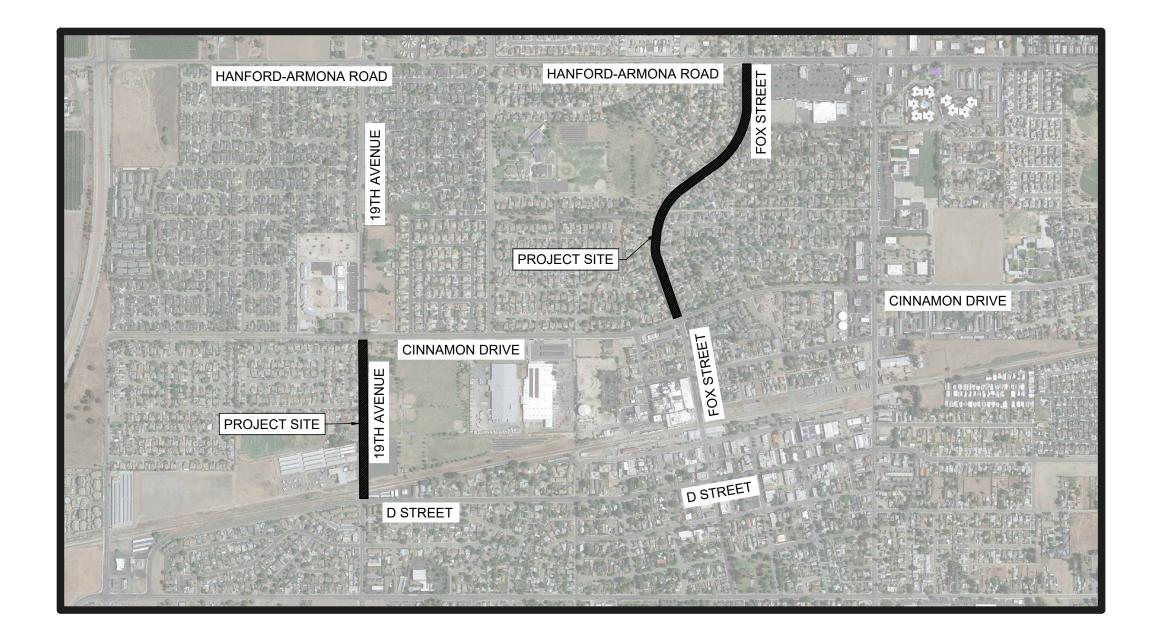

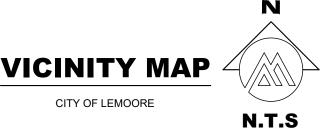

MONUMENTATION PERPETUATION **REQUIREMENTS**

THE CONTRACTOR SHALL BE RESPONSIBLE FOR ANY MONUMENTATION AND/OR BENCHMARKS WHICH WILL BE DISTURBED OR DESTROYED BY CONSTRUCTION. ANY MONUMENT OR BENCHMARK FOUND TO BE DISTURBED OR DESTROYED WILL BE THE REASONABILITY OF THE CONTRACTOR AND PAID BY THE CONTRACTOR TO REPLACE SUCH MONUMENT OR BENCHMARK, SUCH POINTS SHALL BE REFERENCED AND REPLACED WITH APPROPRIATE MONUMENTATION BY A LICENSED LAND SURVEYOR OR A REGISTERED CIVIL ENGINEER AUTHORIZED TO PRACTICE LAND SURVEYING. A CORNER RECORD OR RECORD OF SURVEY, AS APPROPRIATE, SHALL BE FILED BY THE LICENSED LAND SURVEYOR OR CIVIL ENGINEER AS REQUIRED BY THE PROFESSIONAL LAND SURVEYORS ACT (BUSINESS AND PROFESSIONS CODE SECTION 8771).

THE CONTRACTOR SHALL NOTIFY THE ENGINEER AND RECEIVE THE ENGINEER'S APPROVAL TO COMMENCE WORK ONCE ALL EXISTING ROADWAY MONUMENTS HAVE BEEN NOTED & PROTECTED IN

SCOPE OF WORK

THE PURPOSE OF THIS PROJECT IS TO IMPROVE TRAVEL ALONG SEGMENTS OF 19TH AVENUE AND FOX STREET WITHIN THE CITY OF LEMOORE AND PROVIDE INCREASED SAFETY FOR DRIVERS, PEDESTRIANS, AND BICYCLISTS. THE SEGMENT FOR FOX STREET IS APPROXIMATELY 1/2 MILE LONG WHILE THE SEGMENT FOR 19TH AVENUE IS

FOX STREET REPLACES CONCRETE CURBS, GUTTERS, AND SIDEWALKS DAMAGED BY TREE AND/OR STUMP ROOTS. TREES AND/OR STUMPS THAT HAVE DAMAGED THE CONCRETE FACILITIES WILL BE REMOVED, ROOTS GRINDED, AND REPLACED WITH 15

THIS PROJECT CONTAINS AN OVERLAY FOR FOX STREET BETWEEN HANFORD-ARMONA ROAD AND HANOVER AVENUE. A MICRO-SURFACING TREATMENT WILL CONTINUE FROM HANOVER AVENUE TO CINNAMON DRIVE. 19TH AVENUE CONTAINS AN OVERLAY BETWEEN CINNAMON DRIVE AND D STREET. BOTH 19TH AVENUE AND FOX STREET WILL CONTAIN SIGNAGE, STRIPING, AND MARKING

INDEX OF PLANS

- COVER SHEET
- NOTES & LEGEND
- 3. FOX STREET DEMOLITION PLAN
- 4. FOX STREET DEMOLITION PLAN 5. FOX STREET - DEMOLITION PLAN
- 6. COVENTRY DRIVE ADDITIVE DEMOLITION PLAN
- 7. FOX STREET SIDEWALK IMPROVEMENT PLAN
- 8. FOX STREET SIDEWALK IMPROVEMENT PLAN
- 9. FOX STREET SIDEWALK IMPROVEMENT PLAN
- 10. COVENTRY DRIVE ADDITIVE SIDEWALK IMPROVEMENT PLAN
- 11. FOX STREET OVERLAY IMPROVEMENT PLAN
- 12. FOX STREET OVERLAY IMPROVEMENT PLAN 13. FOX STREET - MICROSURFACING IMPROVEMENT PLAN
- 14. FOX STREET SIGNAGE, STRIPING & MARKING PLAN
- 15. FOX STREET SIGNAGE, STRIPING & MARKING PLAN
- 16. FOX STREET SIGNAGE, STRIPING & MARKING PLAN
- 17. 19TH AVENUE DEMOLITION PLAN
- 18. 19TH AVENUE DEMOLITION PLAN
- 19. 19TH AVENUE OVERLAY IMPROVEMENT PLAN
- 20. 19TH AVENUE OVERLAY IMPROVEMENT PLAN
- 15. FOX STREET SIGNAGE, STRIPING & MARKING PLAN
- 16. FOX STREET SIGNAGE, STRIPING & MARKING PLAN
- 17. 19TH AVENUE DEMOLITION PLAN
- 18. 19TH AVENUE DEMOLITION PLAN
- 19. 19TH AVENUE OVERLAY IMPROVEMENT PLAN 20. 19TH AVENUE - OVERLAY IMPROVEMENT PLAN
- 21. 19TH AVENUE SIGNAGE, STRIPING & MARKING PLAN
- 22. 19TH AVENUE SIGNAGE, STRIPING & MARKING PLAN
- 24. DETAILS
- 25. DETAILS

(559) 924-6744 EXT.731

26. SIGNAGE, STRIPING & MARKING DETAILS

CITY & ENGINEER CONTACTS

PUBLIC WORKS DIRECTOR CIVIL ENGINEER

ESTEVAN BENAVIDES ORFIL MUNIZ, PE, QSD, QSIP, sUAS CITY OF LEMOORE A&M CONSULTING ENGINEERS 711 W CINNAMON DRIVE 220 N LOCUST ST LEMOORE, CA 93245 VISALIA, CA 93291

(559) 429-4747

PROJECT UTILITY CONTACTS


CITY OF LEMOORE WATER AND MATT HOUSE WASTEWATER **ESTEVAN BENAVIDES** 705 P STREET 711 W CINNAMON DRIVE FRESNO, CA 93760 LEMOORE, CA 93245 (559)263-5559 MASHP@PGE.COM (559) 924-6730

VAST NETWORKS (CVIN LLC) SOUTHERN CALIFORNIA GAS CO RYAN STUEHLER MARSHALL CROTTY 7447 N PALM BLUFFS AVE #105 404 N TIPTON STREET FRESNO, CA 93711 VISALIA, CA 93292 (559) 554-9114 (559) 739-2356 RSTUEHLER@CVIN.COM MCROTTY@SEMPRAUTILITIES.COM

AT&T COMCAST MARTINA GOMEZ MIKE WILSON 217 W ACEQUIA AVE 3RD FLOOR 1031 N PLAZA DRIVE VISALIA, CA 93291 VISALIA, CA 93291 (559) 739-6423 (925) 424-0278 MARTINA_GOMEZ@CABLE.COMCAST.COM MW7046@ATT.COM





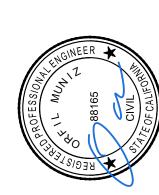







S XO



ABBREVIATIONS & LEGEND

EXISTING MANHOLE COVER

EXISTING VALVE COVER

EXISTING UTILITY BOX

EXISTING CURB DRAIN INLET

EXISTING SIGN AND POST

EXISTING LOOP DETECTOR D

EXISTING LOOP DETECTOR E

PROPOSED LOOP DETECTOR D

PROPOSED LOOP DETECTOR E

PROPOSED CHINESE PISTACHE

EXISTING TREE STUMP

EXISTING FIRE HYDRANT

PROPOSED SIGN AND POST

EXISTING GUY WIRE

BLUE ROAD REFLECTOR

PROPOSED SIGN AND MOUNTING BRACKETS

EXISTING STRIPING OR MARKING TO BE REMOVED BY SANDING OR WATER BLASTING

EXISTING TREE

EXISTING MONUMENT

A.B. A.C.	AGGREGATE BASE ASPHALT CONCRETE
AH	AMPERE HOURS
AVE	AVENUE
BSW C	BACK OF SIDEWALK
CA	CONCRETE CALIFORNIA
CR	CROWN
CITY	CITY OF LEMOORE
DIA DP	DIAMETER DEPTH
DR	DRIVE
EA	EACH
EP ELEV	EDGE OF PAVEMENT
ELEV ETC.	ELEVATION ETCETERA
EX	EXISTING
FL	FLOW LINE
FT	FEET
GB GM	GRADE BREAK GRAMS
GPM	GALLONS PER MINUTE
HMA	HOT MIX ASPHALT
IN ID\\//I	INCH
IRWL LBS	IN-ROADWAY WARNING LIGHT POUNDS
LF	LINEAR FEET
LN	LANE
L.S. MM	LAND SURVEYOR MILLIMETER
MIN	MINIMUM
MAX	MAXIMUM
NO.	NUMBER
NOS. N.T.S.	NUMBERS NOT TO SCALE
OE	OVERHEAD ELECTRICAL
OC	ON CENTER
O.D.	OUTSIDE DIAMETER
OG P	ORIGINAL GROUND PAVEMENT
PCB	PRESSURE-COMPENSATING BUBBLER
PM	PARCEL MAP
P.S.I R.C.	POUNDS PER SQUARE INCH
R.C.E	RELATIVE COMPACTION RESOURCE CONSULTANTS AND ENGINEERS
RD	ROAD
RSP	REFERENCE SAMPLE PROGRAM
R/W SCH.	RIGHT-OF-WAY SCHEDULE
SD SD	STORM DRAIN
SF	SQUARE FEET
SS	SANITARY SEWER
SY TC	SQUARE YARDS TOP OF CURB
T.I.	TRAFFIC INDEX
TYP	TYPICAL
,	EXISTING ELEVATION
	PROPOSED SLOPE IN DECIMAL EXISTING SLOPE IN DECIMAL
ST	STREET
STD.	STANDARD
SPECS	SPECIFICATIONS
V W	VOLTS WATERLINE
,	FEET
	INCHES
°F	DEGREES IN FAHRENHEIT

	EXISTING 0.30' CONCRETE FACILITIES
	EXISTING ASPHALT CONCRETE PAVEMENT
	GRIND 0.30' AND DISPOSE OF EXISTING ASPHALT CONCRETE PAVEMENT
	SIDEWALK, CURB, & GUTTER DEMOLITION
4	PROPOSED 3.5" CONCRETE IMPROVEMENTS
	REMOVE AND REPLACE 0.30' HMA TYPE A OVER EXISTING AGGREGATE BASE COMPACTED 12" AT 95% RELATIVE COMPACTION.
	LIMITS OF TYPE II (0.15 TO 0.20%) FIBERIZED MICRO-SURFACE PAVEMENT TREATMENT WITH BLACK ROCK
(OE)	EXISTING OVERHEAD ELECTRICITY
(W)	EXISTING WATERLINE
	ROAD CROWN LINE
***************************************	EXISTING RAILROAD TRACKS
(SS)	EXISTING SANITARY SEWER LINE
———— (SD) ————	EXISTING STORM DRAIN LINE
$\stackrel{\textstyle \longleftarrow}{\longrightarrow}$	EXISTING DRAINAGE FLOW DIRECTION

CONTRACTOR DEMOLITION NOTES

- 1. IT IS THE RESPONSIBILITY OF THE CONTRACTOR TO PRESERVE ALL SURVEY MONUMENTS. ANY MONUMENT DISTURBED DURING CONSTRUCTION SHALL BE PERPETUATED PER THE PROFESSIONAL LAND SURVEYOR'S ACT, BUSINESS AND PROFESSIONS CODE 8771, AT THE CONTRACTORS EXPENSE.
- 2. LOCATIONS OF EXISTING UTILITIES ARE APPROXIMATED. CONTRACTOR TO FIELD VERIFY ALL EXISTING UTILITIES BEFORE COMMENCEMENT OF WORK AND PROTECT ALL EXISTING UTILITIES, INCLUDING THOSE NOT SHOWN, OR INCORRECTLY SHOWN ON PLANS.
- 3. ALL SIDEWALKS AREAS TO BE GRINDED SHALL BE AT A 4% MAXIMUM SLOPE WITH 1.5% MAXIMUM CROSS SLOPE. GRIND DIMENSIONS WILL VARY FROM AREA TO AREA AS MARKED IN THE FIELD.
- 4. ALL AREAS NOT CLEARLY MARKED FOR DEMOLITION OR GRINDING THAT BECOME DAMAGED OR DESTROYED IN THE PROCESS OF CONSTRUCTING THE IMPROVEMENTS, SHALL BE REPLACED IN-KIND AT THE CONTRACTOR'S OWN EXPENSE.
- 5. SIDEWALK, CURB, AND GUTTER SECTIONS FOR DEMOLITION AND GRINDING ARE MARKED IN THE FIELD. CONTRACTOR SHALL CONTACT THE ENGINEER FOR CLARIFICATION IF MARKINGS ARE UNCLEAR.
- 6. ALL EXISTING THERMOPLASTIC WITHIN THE MICRO-SURFACING PROJECT AREA SHALL BE REMOVED BY GRINDING PRIOR TO APPLYING MICRO-SURFACING TREATMENT.
- 7. CONTRACTOR SHALL MAINTAIN CONTINUOUS ACCESS TO ALL DRIVEWAYS, INCLUDING APARTMENT COMPLEX ENTRANCES, DURING GRINDING AND PAVING OPERATIONS. PROVIDE TEMPORARY TRANSITIONS AS NEEDED TO ENSURE SAFE VEHICULAR ACCESS.
- 8. SAWCUT EXISTING CONCRETE AND ASPHALT CONCRETE PAVEMENT WITH NEAT CLEAN EDGE LINES.
- 9. DEMOLITION AREA CONSISTS OF BUT IS NOT LIMITED TO THE REMOVAL AND DISPOSAL OF EXISTING SURFACES, ASPHALT, CONCRETE, VEGETATION, TREE STUMPS, MINOR LANDSCAPE AREAS, SIGNAGE, MARKINGS, AND STRIPING.
- 10. ANY CONTRACTOR PERFORMING WORK ON THIS PROJECT SHALL FAMILIARIZE THEMSELVES WITH THIS SITE AND SHALL BE SOLELY RESPONSIBLE FOR ANY DAMAGE TO EXISTING FACILITIES RESULTING DIRECTLY OR INDIRECTLY FROM THEIR OPERATIONS, WHETHER OR NOT SUCH FACILITIES ARE SHOWN ON
- 11. CONTRACTOR SHALL COORDINATE WITH RESIDENTS TO MAINTAIN ACCESS TO RESIDENCES ALONG PROJECT LIMITS.
- 12. ANY EXISTING SPRINKLER SYSTEM WITHIN THE DEMOLITION AREA SHALL BE REMOVED, REROUTED, AND RESTORED TO EXISTING FUNCTIONING CONDITION.

CONTRACTOR OVERLAY IMPROVEMENT NOTES

- 1. IT IS THE RESPONSIBILITY OF THE CONTRACTOR TO PRESERVE ALL SURVEY MONUMENTS. ANY MONUMENT DISTURBED DURING CONSTRUCTION SHALL BE PERPETUATED PER THE PROFESSIONAL LAND SURVEYOR'S ACT, BUSINESS AND PROFESSIONS CODE 8771, AT THE CONTRACTORS EXPENSE.
- 2. LOCATIONS OF EXISTING UTILITIES ARE APPROXIMATED. CONTRACTOR TO FIELD VERIFY ALL EXISTING UTILITIES BEFORE COMMENCEMENT OF WORK. NO ADDITIONAL PAYMENT SHALL BE AUTHORIZED FOR DAMAGES RESULTING FROM IMPACTS TO EXISTING UTILITIES.
- 3. IT IS THE RESPONSIBILITY OF THE CONTRACTOR TO PROTECT AND ADJUST UTILITY COVERS AND ENCASEMENT WITHIN THE CONSTRUCTION WORK TO PREVENT DAMAGES. NO ADDITIONAL PAYMENT SHALL BE AUTHORIZED FOR DAMAGES TO UTILITY COVERS.
- 4. DIMENSIONS ARE FROM LIP OF GUTTER AND MAY VARY AT DRIVEWAY FLARES.
- 5. ALL DIMENSIONS AND CROSS SLOPE PERCENTAGES ARE APPROXIMATE. FIELD VERIFY DIMENSIONS PRIOR TO CONSTRUCTION.
- 6. SEE DETAIL C ON SHEET 25 FOR MEDIAN ISLAND SECTIONS OF OVERLAY IMPROVEMENTS.
- 7. SEE DETAIL D ON SHEET 25 FOR TYPICAL SECTIONS OF OVERLAY IMPROVEMENTS.

CONTRACTOR MICRO-SURFACING NOTES

- 1. IT IS THE RESPONSIBILITY OF THE CONTRACTOR TO PRESERVE ALL SURVEY MONUMENTS. ANY MONUMENT DISTURBED DURING CONSTRUCTION SHALL BE PERPETUATED PER THE PROFESSIONAL LAND SURVEYOR'S ACT, BUSINESS AND PROFESSIONS CODE 8771, AT THE
- 2. LOCATIONS OF EXISTING UTILITIES ARE APPROXIMATED. CONTRACTOR TO FIELD VERIFY ALL EXISTING UTILITIES BEFORE COMMENCEMENT OF WORK. NO ADDITIONAL PAYMENT SHALL BE AUTHORIZED FOR DAMAGES RESULTING FROM IMPACTS TO EXISTING UTILITIES.
- 3. IT IS THE RESPONSIBILITY OF THE CONTRACTOR TO PROTECT UTILITY COVERS AND ENCASEMENT WITHIN THE CONSTRUCTION WORK TO PREVENT DAMAGES. NO ADDITIONAL PAYMENT SHALL BE AUTHORIZED FOR DAMAGES TO UTILITY COVERS.
- 4. SHOULD THE CONTRACTOR FIND POTHOLES OR AREAS THAT REQUIRE PATCHWORK DURING CONSTRUCTION THAT ARE NOT IN THE PLANS, THEY MUST PROMPTLY PATCH THEM WITH THE ENGINEER'S APPROVAL PRIOR TO MICRO-SURFACING OPERATIONS. THIS REQUIREMENT APPLIES TO THE BASE BID.
- 5. CONTRACTOR SHALL PROVIDE CRACK SEAL TREATMENT FOR CRACKS MEASURING 0.25" TO 1" IN WIDTH. CRACKS LARGER THAN 1" SHALL BE PROVIDED WITH CRACK FILLING AND CRACK SEALING. THIS REQUIREMENT APPLIES TO THE BASE BID.

CONTRACTOR STRIPING NOTES


- 1. ALL EXISTING PAVEMENT STRIPING & MARKINGS (CROSSWALKS, STOP BARS, STOP MARKING LEGENDS, CENTERLINE, ETC.) SHALL BE REPAINTED WHEN DISTURBED BY MICRO-SURFACING TREATMENT, UNLESS SPECIFIED OTHERWISE.
- 2. CONTRACTOR TO REPLACE EXISTING REFLECTORS DISTURBED BY OVERLAY AND MICRO-SURFACING TREATMENT AND ADD REFLECTORS WHERE CURRENTLY MISSING.
- 3. BIKE LANE WIDTH SHALL BE 5 FEET WIDE UNLESS SPECIFIED OTHERWISE.

SIGNING, STRIPING & MARKING NOTES

- 1. ALL WORK AND MATERIALS SHALL CONFORM TO CALTRANS STANDARD PLANS (2024 REVISED STANDARD PLAN RSP) AND THE LATEST EDITION OF THE CA 2014 MANUAL ON UNIFORM TRAFFIC CONTROL DEVICES FOR STREETS AND HIGHWAYS MUTCD.
- 2. ANY CONTRACTOR PERFORMING WORK ON THIS PROJECT SHALL FAMILIARIZE THEMSELVES WITH THIS SITE AND SHALL BE SOLELY RESPONSIBLE FOR ANY DAMAGE TO EXISTING FACILITIES RESULTING DIRECTLY OR INDIRECTLY FROM THEIR OPERATIONS, WHETHER OR NOT SUCH FACILITIES ARE SHOWN ON THESE PLANS.
- 3. ALL STRIPING MUST BE CAT-TRACKED AND APPROVED BY THE ENGINEER BEFORE COMMENCING WORK. ANY STRIPPING WHICH IS NOT APPROVED BY THE ENGINEER AND IS DETERMINED TO BE IN CONFLICT WITH ANY OTHER STRIPPING OR OBJECTS SHALL BE REMOVED AT THE CONTRACTOR'S EXPENSE.
- 4. CONTRACTOR SHALL PROVIDE BLUE REFLECTIVE MARKER NEXT TO EVERY FIRE HYDRANT PER CITY STD. NO. W-6 ON SHEET 25. FIRE HYDRANT LOCATIONS SHALL BE FIELD VERIFIED.
- 5. CONTRACTOR TO PROVIDE TEMPORARY REFLECTIVE MARKERS AND TO PROTECT IN PLACE AFTER INSTALLATION. ANY MARKER THAT IS DAMAGED AND IS NO LONGER REFLECTIVE SHALL BE REMOVED AND REPLACED AT THE CONTRACTOR'S EXPENSE. CONTRACTOR SHALL HAVE THE OPTION OF PLACING TEMPORARY MARKERS IMMEDIATELY AFTER ROADWAY TREATMENT TO AVOID REFLECTIVE MARKER
- 6. ALL EXISTING THERMOPLASTIC WITHIN THE MICRO-SURFACING PROJECT AREA SHALL BE REMOVED BY GRINDING PRIOR TO APPLYING MICRO-SURFACING TREATMENT.





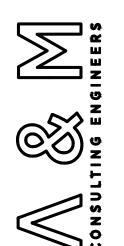



REPAIR OF LEMOORE AVENUE ROADWAY


FOX




SCALE:
JOB NO:
QA/QC:
FILE:

SHEET NO.

Know what's **below. Call 811** before you dig.

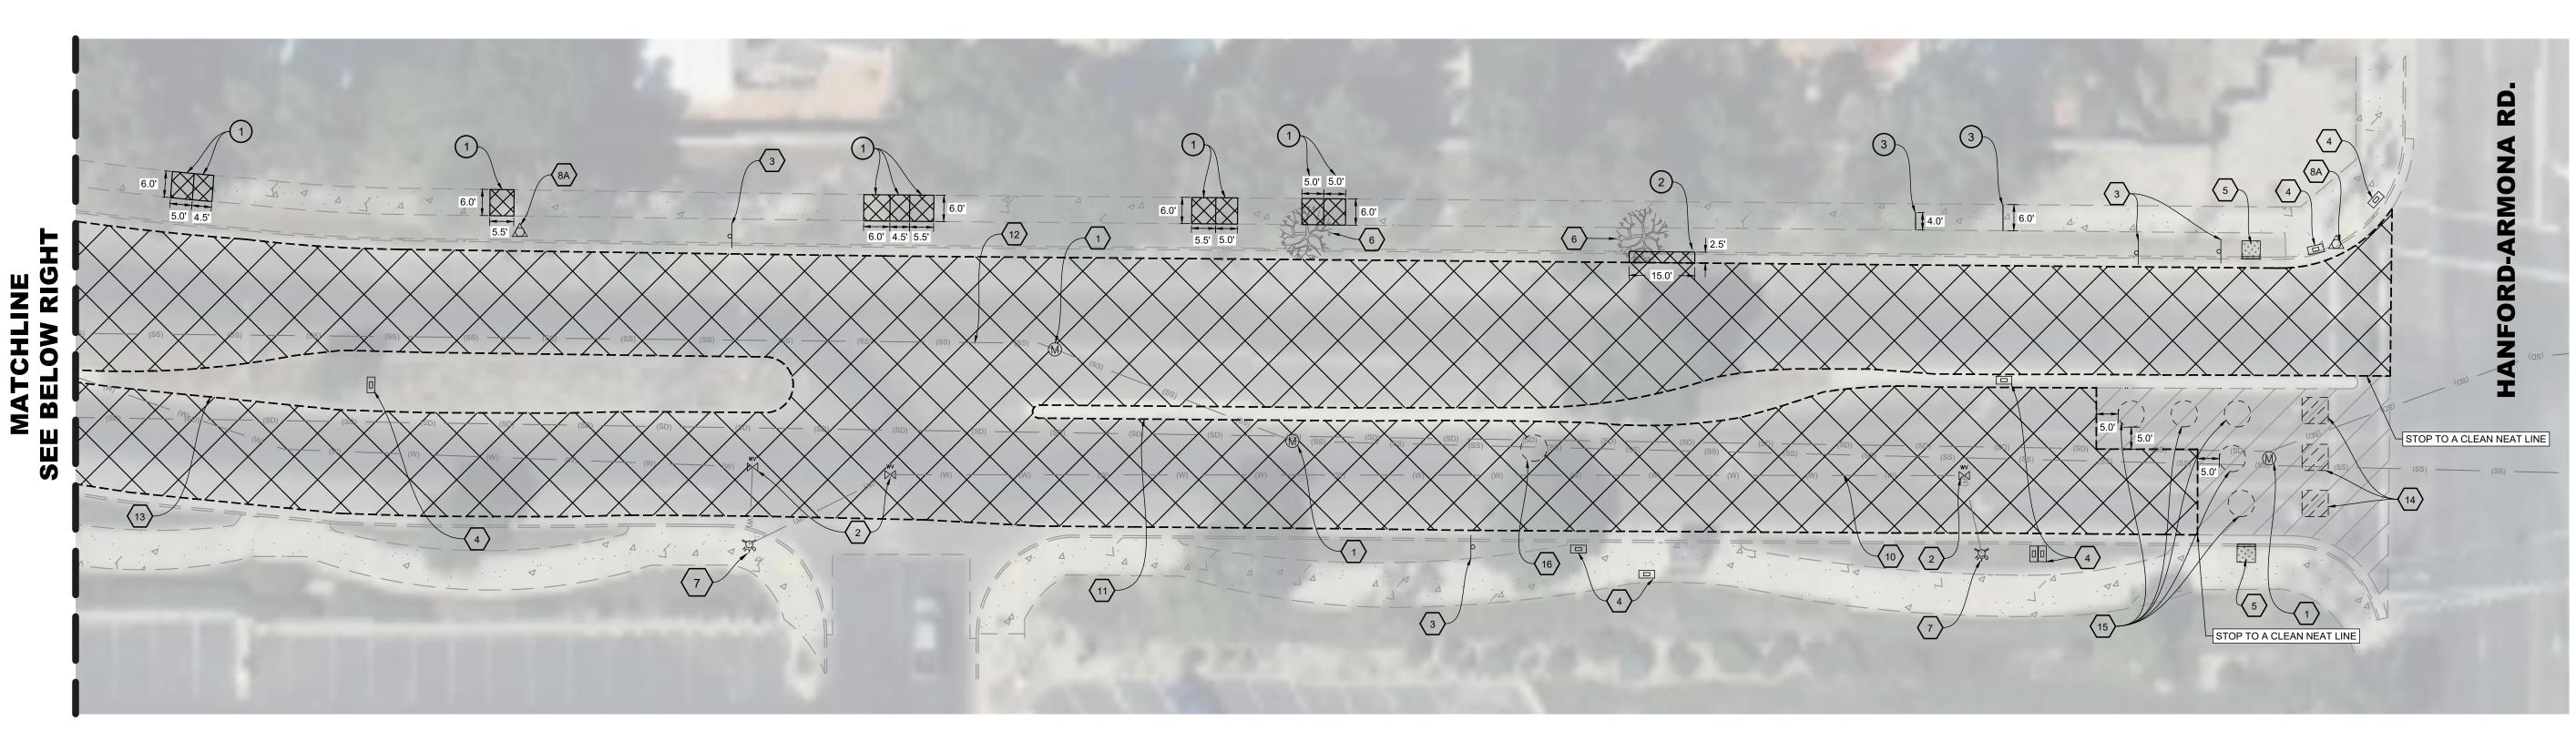

FOX STREET
SCALE: 1" = 20'

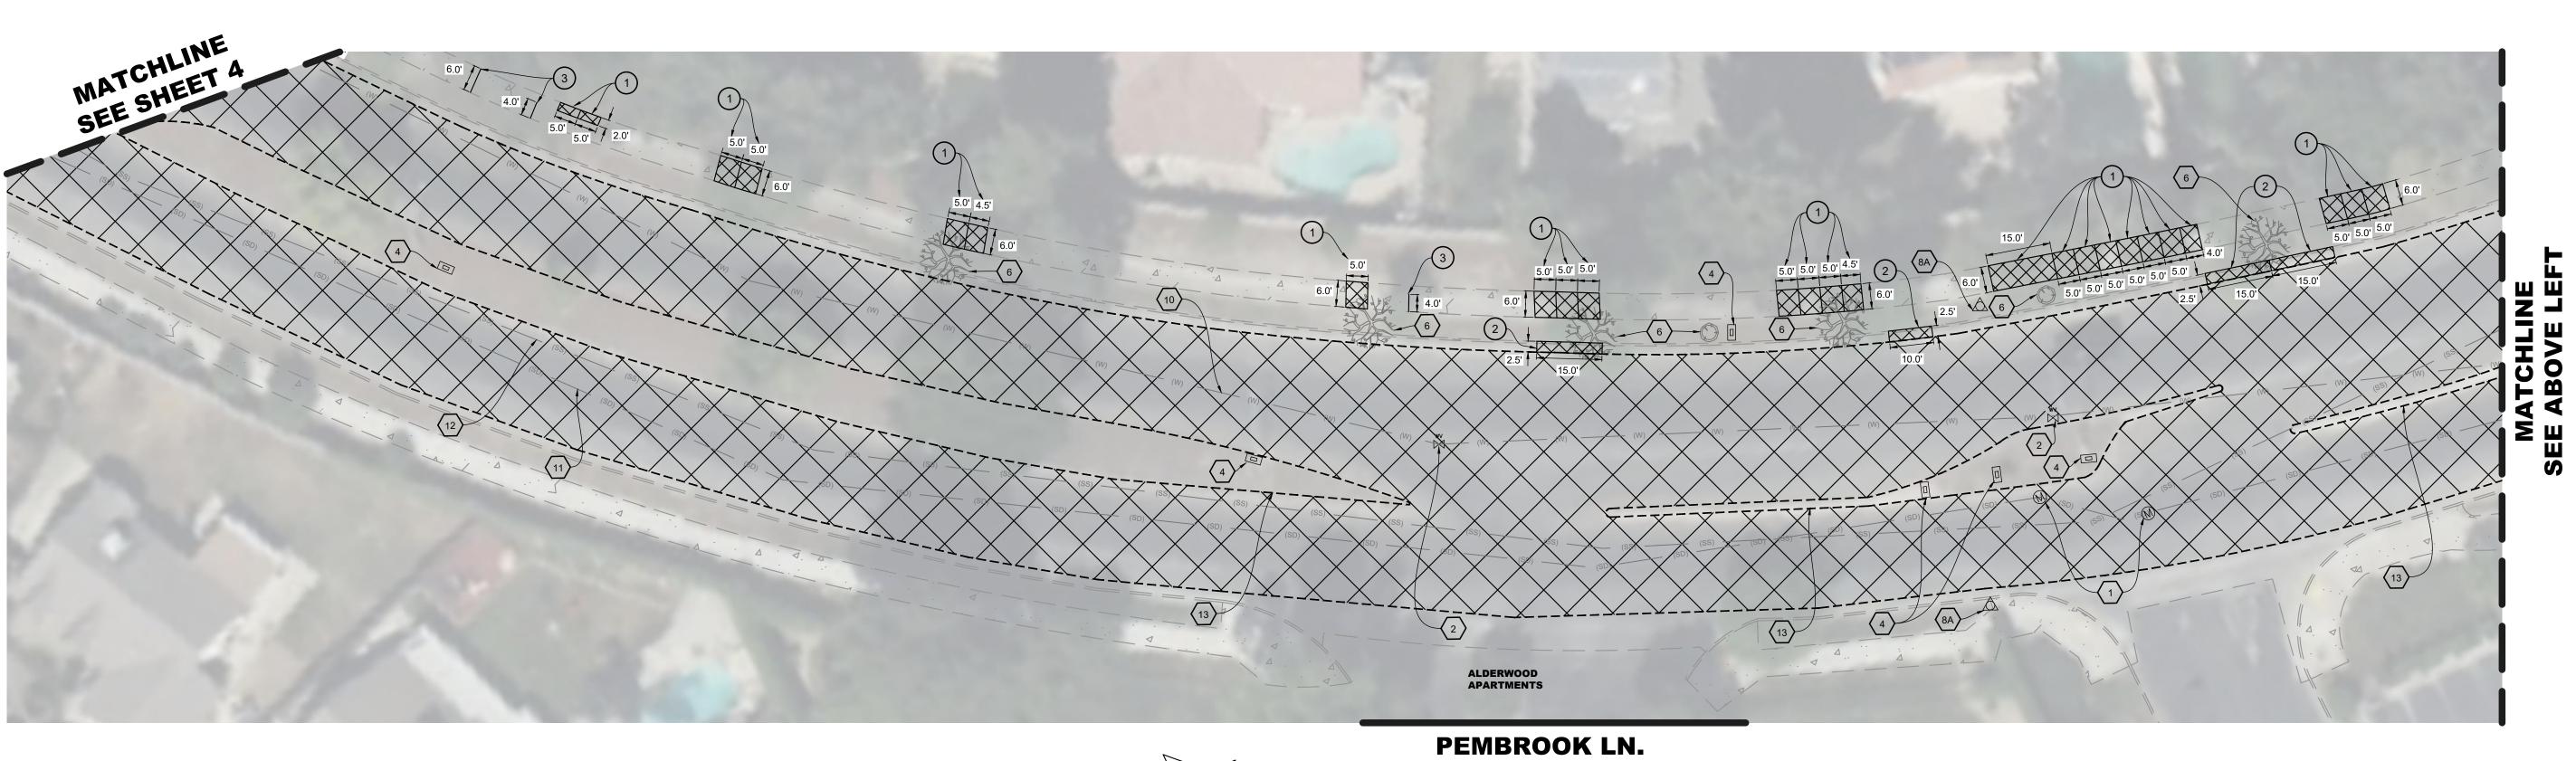

FOX STREET
SCALE: 1" = 20'

DEMOLITION NOTES

CONSTRUCTION NOTES

1.) REMOVE AND DISPOSE OF EXISTING CONCRETE SIDEWALK.

2.) REMOVE AND DISPOSE OF EXISTING CONCRETE CURB & GUTTER.

3. GRIND EXISTING CONCRETE SIDEWALK LENGTH.

LEGEND

SEE SHEET 2

CONTRACTOR DEMOLITION NOTES SEE SHEET 2

SEE SHEET 5



FOX STREET
SCALE: 1" = 20'

FALLENLEAF DR. 26

FOX STREET SCALE: 1" = 20'

CONSTRUCTION NOTES

1. REMOVE AND DISPOSE OF EXISTING CONCRETE SIDEWALK.

LEGEND

SEE SHEET 2

2. REMOVE AND DISPOSE OF EXISTING CONCRETE CURB & GUTTER.

3. GRIND EXISTING CONCRETE SIDEWALK LENGTH.

CONTRACTOR DEMOLITION NOTES


SEE SHEET 2

DEMOLITION NOTES

SEE SHEET 5





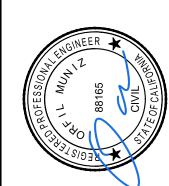

CITY OF LEMOORE

19TH AVENUE ROADWAY REPAIRS

FOX STREET

FOX





CONSTRUCTION NOTES

- 1.) REMOVE AND DISPOSE OF EXISTING CONCRETE SIDEWALK.
- (2.) REMOVE AND DISPOSE OF EXISTING CONCRETE CURB & GUTTER.
- 3.) GRIND EXISTING CONCRETE SIDEWALK LENGTH.

CONTRACTOR DEMOLITION NOTES


SEE SHEET 2

LEGEND

SEE SHEET 2

DEMOLITION NOTES

- 1. PROTECT IN PLACE EXISTING MANHOLE.
- 2. PROTECT IN PLACE EXISTING WATER VALVE.
- $\langle 3. \rangle$ PROTECT IN PLACE EXISTING SIGNS AND POST.
- 4. PROTECT IN PLACE EXISTING UTILITY BOX.
- 5. PROTECT IN PLACE EXISTING CURB DRAIN INLET.
- REMOVE EXISTING TREE AND/OR STUMP AND ROOTS. SEE DETAIL A & TYPICAL REPAIR DETAIL 1 AND 2 ON SHEET 6. PROTECT IN PLACE EXISTING NEARBY CONCRETE FACILITIES.
- 7. PROTECT IN PLACE EXISTING FIRE HYDRANT.
- 8A.) PROTECT IN PLACE EXISTING MONUMENT- 1/2" IRON PIPE L.S. 4714 6" DEEP.
- 8B. PROTECT IN PLACE EXISTING MONUMENT- BRASS DISC FLUSH IN CONCRETE STAMPED L.S. 4714.
- 9. PROTECT IN PLACE EXISTING OVERHEAD ELECTRICITY.
- 10. PROTECT IN PLACE EXISTING WATERLINE.
- 11. PROTECT IN PLACE EXISTING STORM DRAIN SEWER LINE.
- 12. PROTECT IN PLACE EXISTING SANITARY SEWER LINE.
- 13. PROTECT IN PLACE EXISTING MEDIAN CONCRETE CURB.
- 14. PROTECT IN PLACE EXISTING LOOP DETECTOR D.
- 15. PROTECT IN PLACE EXISTING LOOP DETECTOR E.
- 16. REMOVE AND REPLACE EXISTING LOOP DETECTOR E.

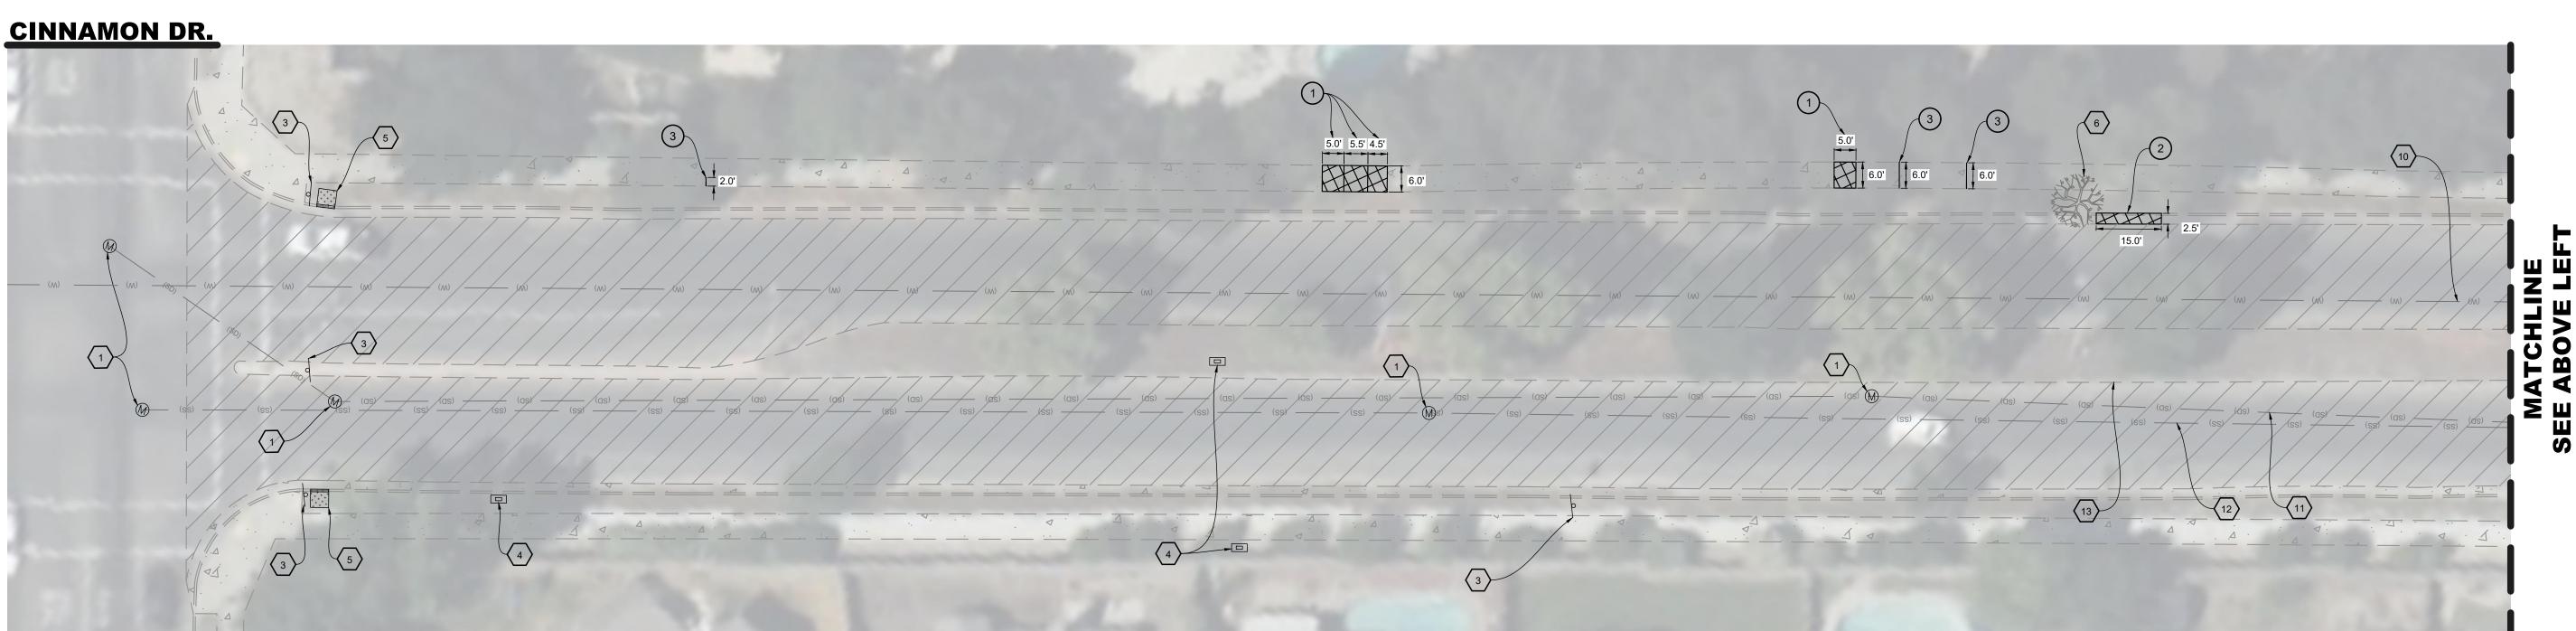


CINNAMON DR.







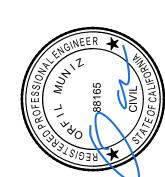

FOX STREET &




SHEET NO.

5

FOX




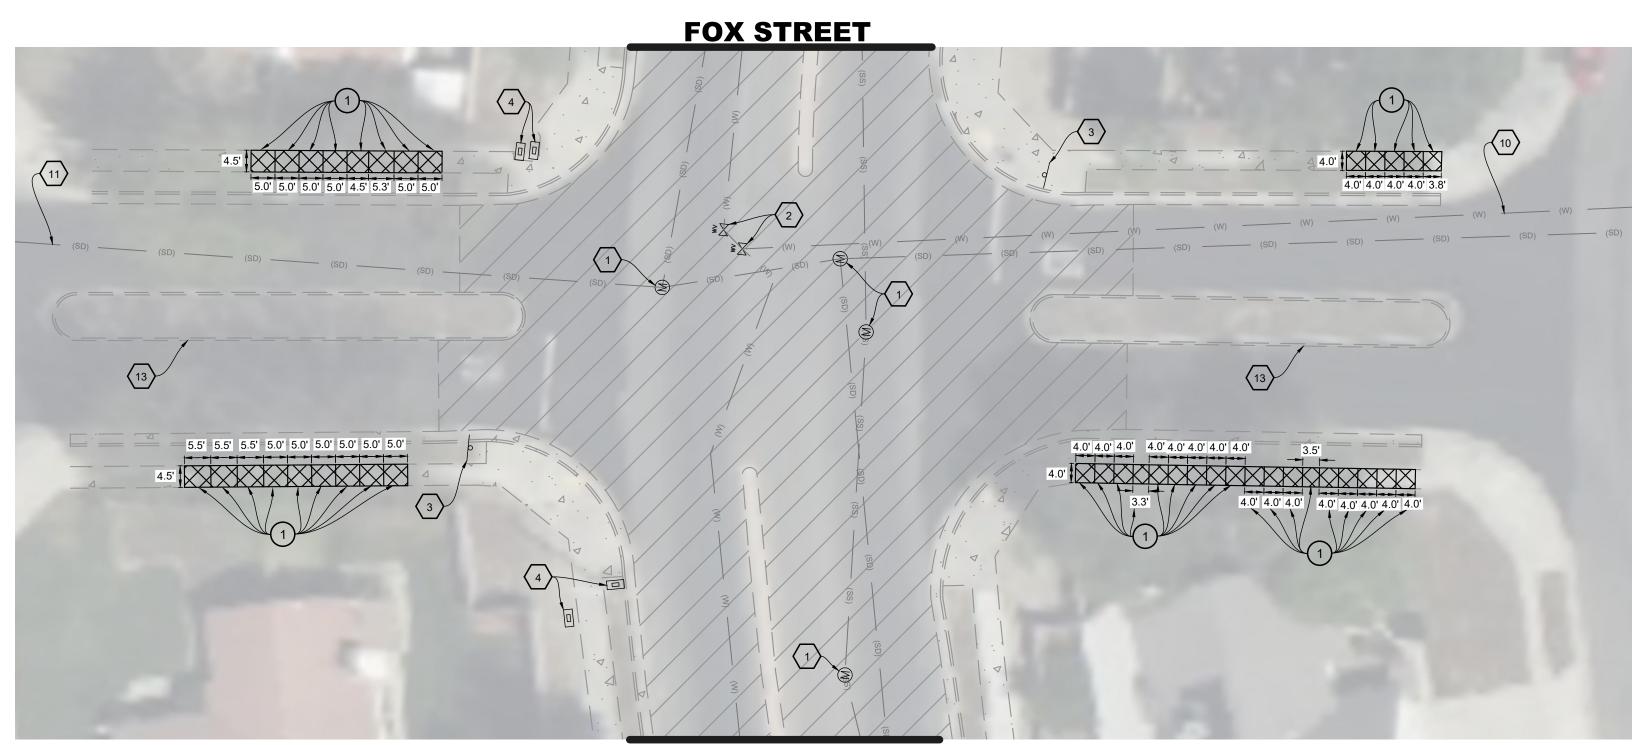


COVENTRY DRIVE SCALE: 1" = 20'



FOX STREET

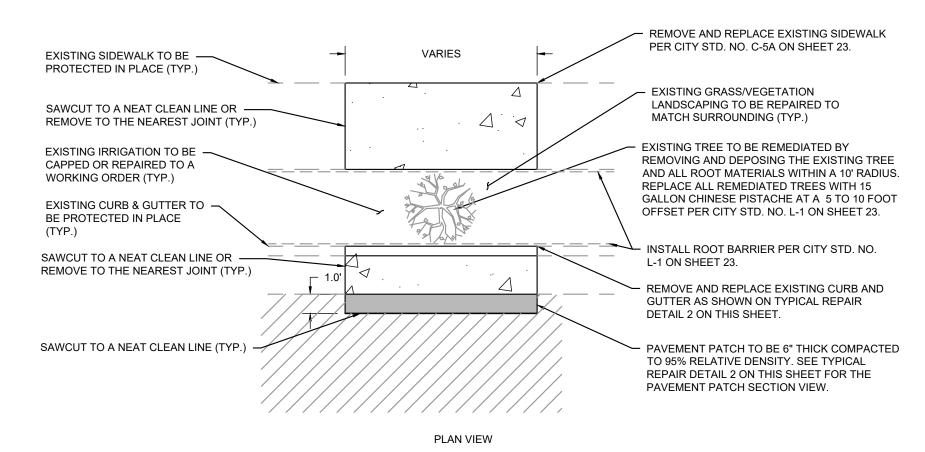

TYPICAL REPAIR DETAIL 1 N.T.S.

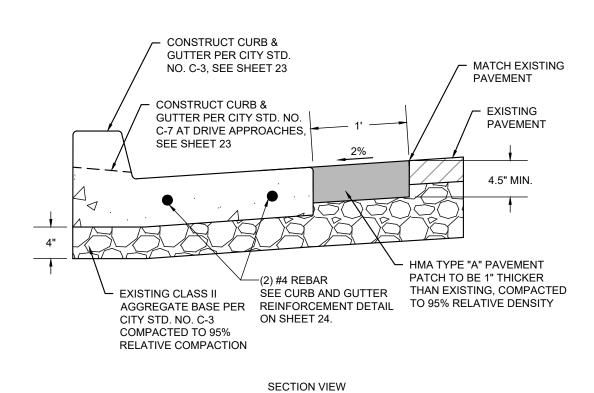

TYPICAL REPAIR DETAIL 2 N.T.S.

CONSTRUCTION NOTES

1.) REMOVE AND DISPOSE OF EXISTING CONCRETE SIDEWALK.

(2.) REMOVE AND DISPOSE OF EXISTING CONCRETE CURB & GUTTER.

3.) GRIND EXISTING CONCRETE SIDEWALK LENGTH.

SEE SHEET 2

SEE SHEET 2

CONTRACTOR DEMOLITION NOTES

LEGEND

8B. PROTECT IN PLACE EXISTING MONUMENT- BRASS DISC FLUSH IN CONCRETE STAMPED L.S. 4714.

1. PROTECT IN PLACE EXISTING MANHOLE.

(2.) PROTECT IN PLACE EXISTING WATER VALVE.

(3.) PROTECT IN PLACE EXISTING SIGNS AND POST.

5. PROTECT IN PLACE EXISTING CURB DRAIN INLET.

EXISTING NEARBY CONCRETE FACILITIES.

PROTECT IN PLACE EXISTING FIRE HYDRANT.

REMOVE EXISTING TREE AND/OR STUMP AND ROOTS. SEE DETAIL A & TYPICAL REPAIR DETAIL 1 AND 2 ON THIS SHEET. PROTECT IN PLACE

8A. PROTECT IN PLACE EXISTING MONUMENT- 1/2" IRON PIPE L.S. 4714 6" DEEP.

4. PROTECT IN PLACE EXISTING UTILITY BOX.

9. PROTECT IN PLACE EXISTING OVERHEAD ELECTRICITY.

10. PROTECT IN PLACE EXISTING WATERLINE.

11. PROTECT IN PLACE EXISTING STORM DRAIN SEWER LINE.

12. PROTECT IN PLACE EXISTING SANITARY SEWER LINE.

13. PROTECT IN PLACE EXISTING MEDIAN CONCRETE CURB.

14. PROTECT IN PLACE EXISTING LOOP DETECTOR D.

15. PROTECT IN PLACE EXISTING LOOP DETECTOR E.

16. REMOVE AND REPLACE EXISTING LOOP DETECTOR E.

-PROPOSED NEW SIDEWALK

-PROPOSED NEW

CURB & GUTTER

PLAN VIEW

-REMOVE ROOTS UNDER NEW IMPROVEMENTS -TREE AND/OR STUMP TO BE REMOVED PROPOSED NEW-WITHIN A 10' RADIUS OF THE EXISTING TREE SIDEWALK PER CITY STD. PROPOSED NEW CURB & GUTTER NO. C-5A ON SHEET 23 PER CITY STD. NO. C-5 ON SHEET 23. —SEE CURB AND GUTTER REINFORCEMENT DETAIL —ROOTS TO BE REMOVED— UNDER NEW IMPROVEMENTS -EXISTING CLASS II AGGREGATE BASE-

ELEVATION VIEW

NOTES:

1. CONTRACTOR SHALL REMOVE TREE ROOTS UP TO 1' DEPTH BELOW AGGREGATE BASE AND WITHIN A 10' RADIUS AROUND THE BASE OF THE TREE UNDER NEW IMPROVEMENTS.

2. ROOT SHAVING SHALL BE PERFORMED WITH A MACHINE USING A CITY APPROVED VERTICAL CUTTING WHEEL OR HORIZONTAL BLADE. THE WHEEL SHALL BE NO LONGER THAN 350 MM (14"), WITH CUTTER TEETH. IF A VERTICAL WHEEL IS USED, ROOT SHAVING SHALL BE DONE WITH HORIZONTAL SIDE

3. WHERE EXPANSIVE SOILS ARE ENCOUNTERED UNDER THE CURB, GUTTER, AND SIDEWALK, THE BACKFILL MATERIAL SHALL BE OF IMPORTED SAND COMPACTED TO 90% RELATIVE COMPACTION. SOIL BACKFILL MATERIAL FROM REMOVED TREE AND ROOT AREAS SHALL CONSIST OF 70% NATIVE SOIL AND 30% CLEAN GREENWASTE COMPOST.


DETAIL A - TREE, ROOT, AND STUMP REMOVAL N.T.S.

FOX STREET




SHEET NO.

Know what's **below. Call 811** before you dig.

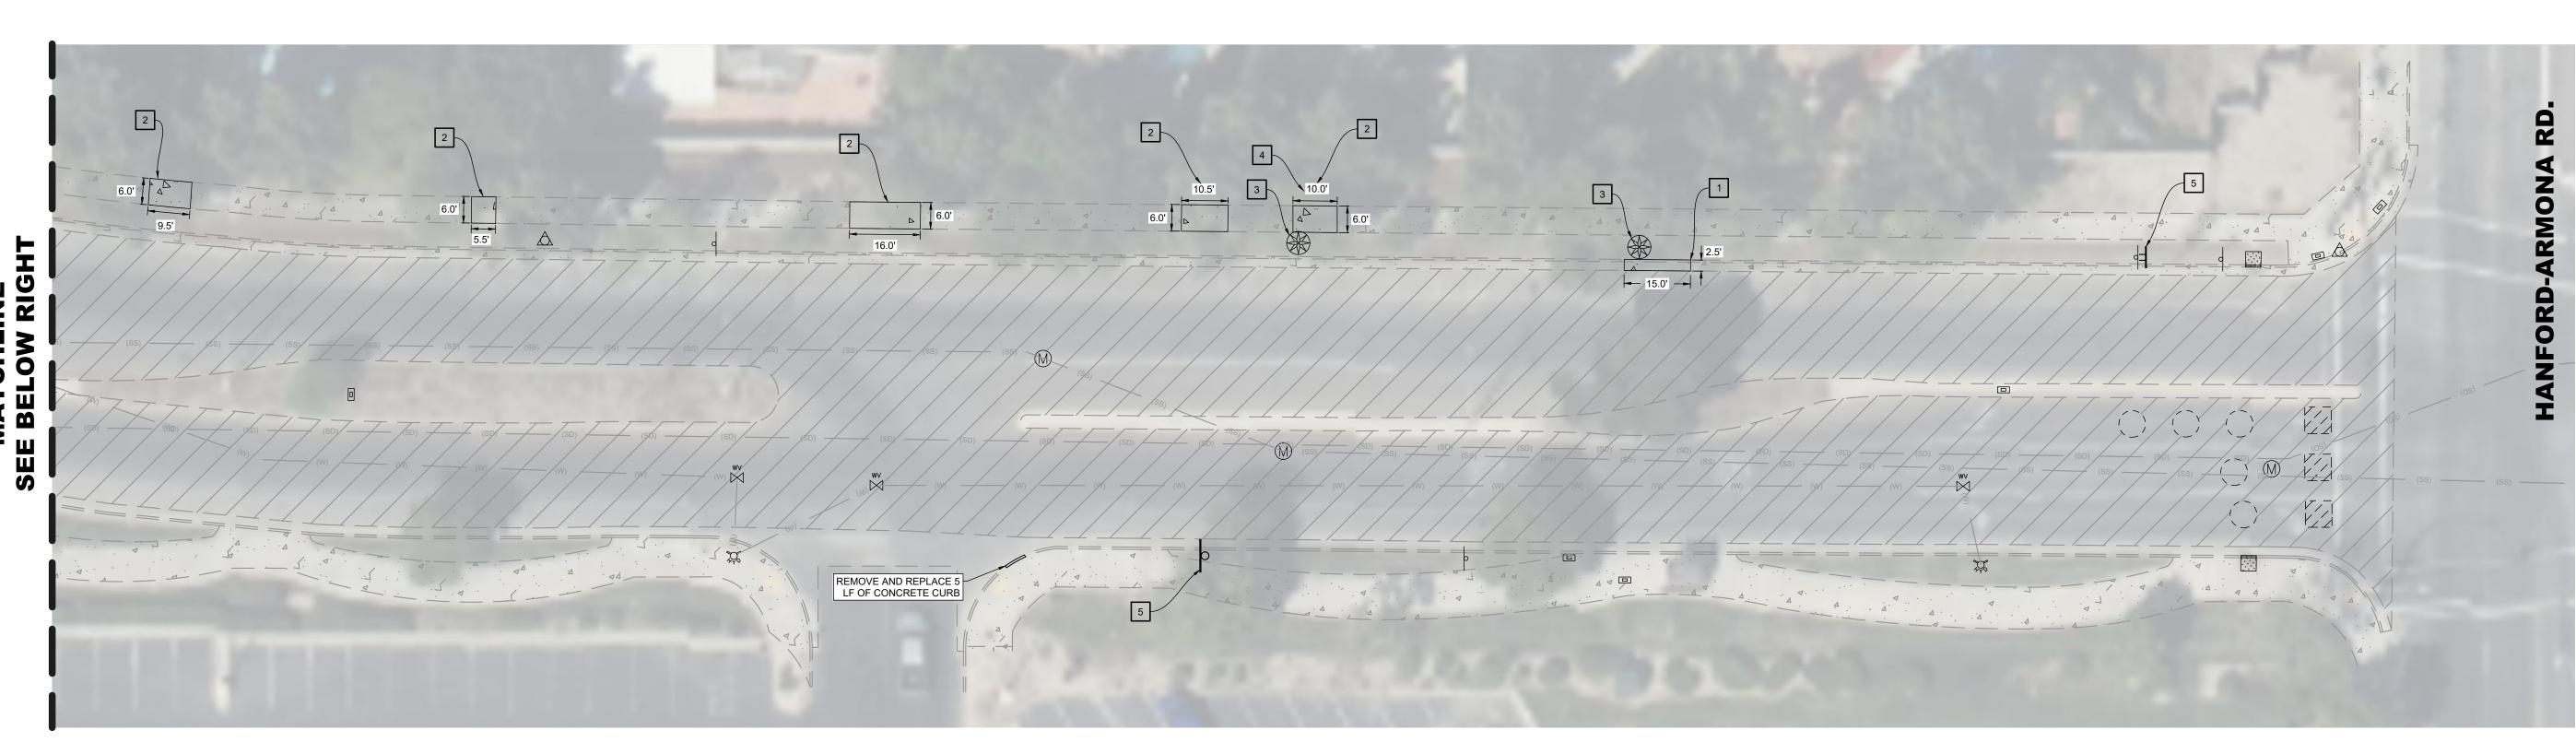

FOX STREET SCALE: 1" = 20'

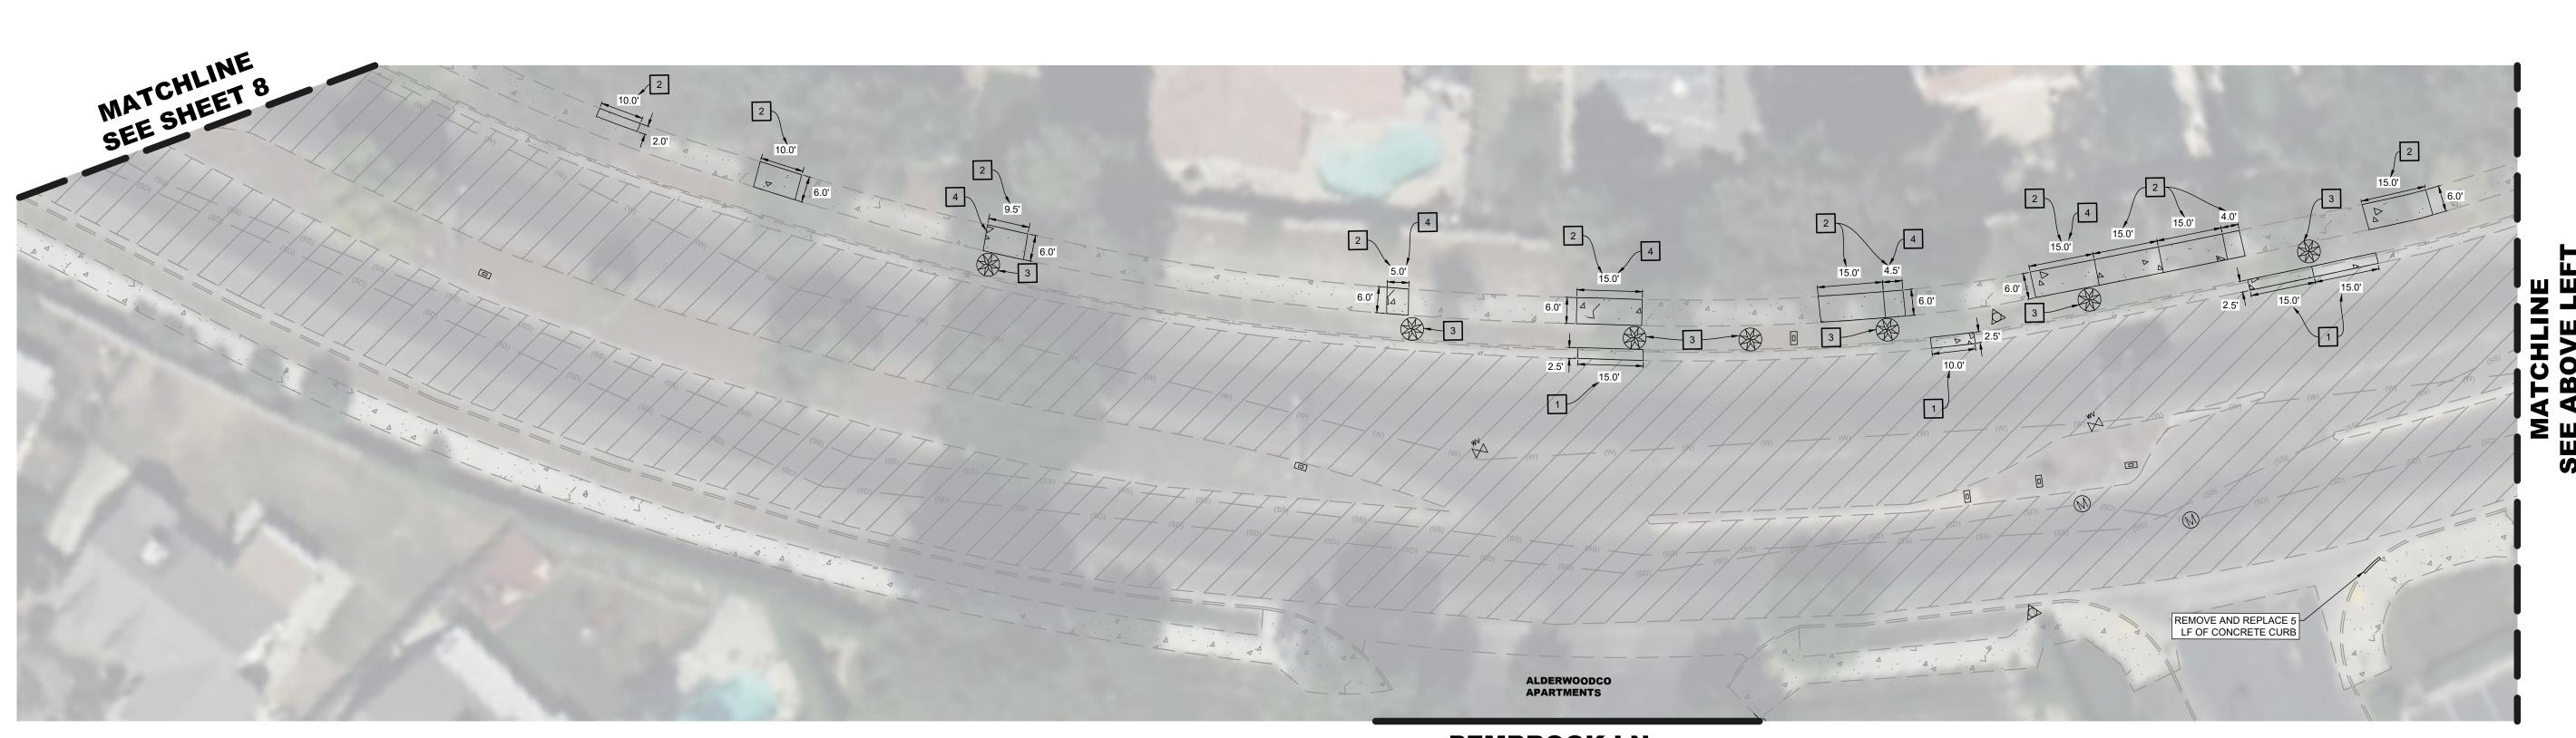

CONSTRUCTION NOTES

- 1. CONSTRUCT CONCRETE CURB & GUTTER IMPROVEMENTS PER CITY STD. NO. C-1, C-2, C-3, C-5A AND PER REINFORCEMENT DETAIL ON SHEET 23 AND 24.
- 2. CONSTRUCT CONCRETE SIDEWALK IMPROVEMENTS PER CITY STD. NO. C-1, C-1A, AND C-5A ON SHEET 23 AND 24.
- 3. REPAIR EXISTING IRRIGATION SYSTEM LOCATED WITHIN A 20' RADIUS OF PROPOSED CHINESE PISTACHE TREES. INSTALL PROPOSED 15 GALLON CHINESE PISTACHE 5 TO 10 FEET FROM REMOVED TREE AND/OR STUMP. INSTALL STANDARD TREE WELL PER CITY STD. NO. L-1, SEE SHEET 23.
- 4. INSTALL IRRIGATION SLEEVE UNDER PROPOSED CONCRETE SIDEWALK IMPROVEMENTS. SEE DETAIL B ON SHEET 10.
- 5. INSTALL SIGN AND POST/MOUNTING BRACKETS. SEE SIGNAGE, STRIPING, AND MARKING PLAN ON SHEET 14, 15, AND 16.

LEGEND SEE SHEET 2

FOX STREET SCALE: 1" = 20'




PEMBROOK LN.

CONTRACTOR NOTES

GENERAL CONCRETE NOTES SEE SHEET 9



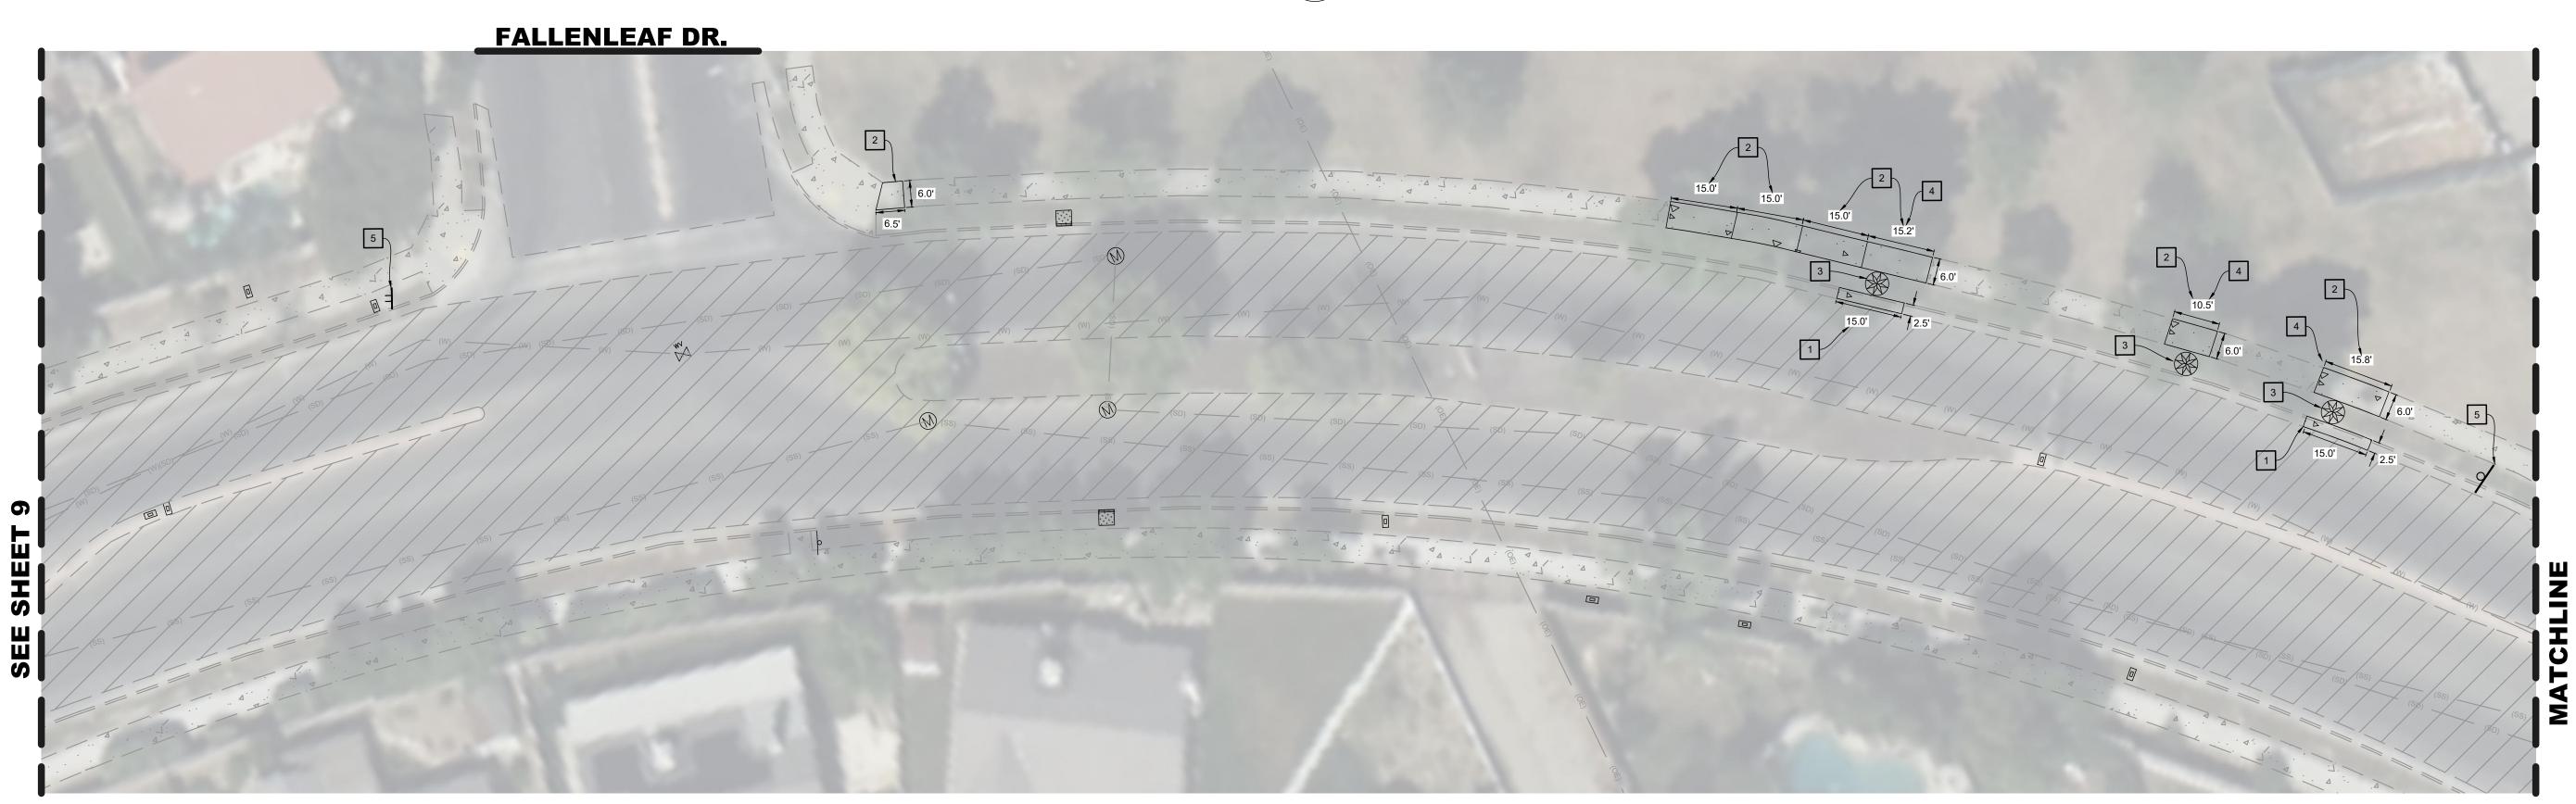

CONSTRUCTION NOTES

1. CONSTRUCT CONCRETE CURB & GUTTER IMPROVEMENTS PER CITY STD. NO. C-1, C-2, C-3, AND C-5A AND PER REINFORCEMENT DETAIL ON SHEET 23 AND 24.

2. CONSTRUCT CONCRETE SIDEWALK IMPROVEMENTS PER CITY STD. NO. C-1, C-1A, C-5A ON SHEET 23 AND 24.

3. REPAIR EXISTING IRRIGATION SYSTEM LOCATED WITHIN A 20' RADIUS OF PROPOSED CHINESE PISTACHE TREES. INSTALL PROPOSED 15 GALLON CHINESE PISTACHE 5 TO 10 FEET FROM REMOVED TREE AND/OR STUMP. INSTALL STANDARD TREE WELL PER CITY STD. NO. L-1, SEE SHEET 23.

4. INSTALL IRRIGATION SLEEVE UNDER PROPOSED CONCRETE SIDEWALK IMPROVEMENTS. SEE DETAIL B ON SHEET 10.

5. INSTALL SIGN AND POST/MOUNTING BRACKETS. SEE SIGNAGE, STRIPING, AND MARKING PLAN ON SHEET 14, 15, AND 16.

LEGEND SEE SHEET 2

FOX STREET
SCALE: 1" = 20'




CONTRACTOR NOTES SEE SHEET 9

GENERAL CONCRETE NOTES

SEE SHEET 9





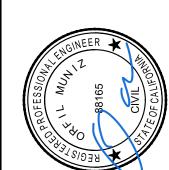

CITY OF LEMOORE

19TH AVENUE ROADWAY REPAIRS SIDEWALK IMPROVEMENT PLAN

FOX STREET

FOX STREET





FOX STREET
SCALE: 1" = 20'

CONSTRUCTION NOTES

- 1. CONSTRUCT CONCRETE CURB & GUTTER IMPROVEMENTS PER CITY STD. NO. C-1, C-2, C-3, AND C-5A AND PER REINFORCEMENT DETAIL ON SHEET 23 AND 24.
- 2. CONSTRUCT CONCRETE SIDEWALK IMPROVEMENTS PER CITY STD. NO. C-1, C-1A, C-5A ON SHEET 23 AND 24.
- 3. REPAIR EXISTING IRRIGATION SYSTEM LOCATED WITHIN A 20' RADIUS OF PROPOSED CHINESE PISTACHE TREES. INSTALL PROPOSED 15 GALLON CHINESE PISTACHE 5 TO 10 FEET FROM REMOVED TREE AND/OR STUMP. INSTALL STANDARD TREE WELL PER CITY STD. NO. L-1, SEE SHEET 23.
- 4. INSTALL IRRIGATION SLEEVE UNDER PROPOSED CONCRETE SIDEWALK IMPROVEMENTS. SEE DETAIL B ON SHEET 10.
- 5. INSTALL SIGN AND POST/MOUNTING BRACKETS. SEE SIGNAGE, STRIPING, AND MARKING PLAN ON SHEET 14, 15, AND 16.

CONTRACTOR NOTES

- IT IS THE RESPONSIBILITY OF THE CONTRACTOR TO PRESERVE ALL SURVEY MONUMENTS. ANY
 MONUMENT DISTURBED DURING CONSTRUCTION SHALL BE PERPETUATED PER THE PROFESSIONAL
 LAND SURVEYOR'S ACT, BUSINESS AND PROFESSIONS CODE 8771, AT THE CONTRACTORS EXPENSE.
- LOCATIONS OF EXISTING UTILITIES ARE APPROXIMATED. CONTRACTOR TO FIELD VERIFY ALL EXISTING UTILITIES BEFORE COMMENCEMENT OF WORK.
- 3. CONTRACTOR TO OFFSET THE PLANTING HOLE OF PROPOSED CHINESE PISTACHE A DISTANCE OF 5 TO 10 FEET FROM THE REMOVED TREE AND/OR STUMP.

GENERAL CONCRETE NOTES

- 1. ALL CONCRETE SHALL BE A MINIMUM OF 5 SACK MIX AND TEST TO A MINIMUM OF 3200 PSI IN 28 DAYS.
- 2. NO CROSS SLOPE IN THE PATH OF TRAVEL SHALL EXCEED 1.5%.
- 3. SIDEWALKS SHALL HAVE A LIGHT BROOM FINISH. ALL BROOMING SHALL BE PARALLEL TO THE DIRECTION OF FLOW.
- 4. ALL WORK CONSIDERED BY THESE PLANS SHALL BE IN COMPLIANCE WITH A.D.A. REGULATIONS.
- 5. WHEN MAXIMUM DAYTIME TEMPERATURE EXCEEDS 50°F, ALL NEWLY PLACED CONCRETE SHALL BE SPRAYED UNIFORMLY WITH A CURING COMPOUND. CURING COMPOUND SHALL BE APPLIED AT A NOMINAL RATE OF ONE GALLON PER 150 S.F., UNLESS OTHERWISE SPECIFIED.
- 6. CONTRACTOR SHALL BE RESPONSIBLE FOR DOWELING INTO ADJACENT CONCRETE IN ORDER TO CONNECT NEW CONCRETE WORK WITH EXISTING.
- 7. CONTRACTOR SHALL SAWCUT AND REMOVE 2' OF ASPHALT PAVEMENT IN FRONT OF REPLACED CURB & GUTTER IN ORDER TO PROPERLY FIT THE CONCRETE FORMS. ASPHALT PATCH SHALL BE MADE PER TYPICAL REPAIR DETAIL 1 AND 2, PROVIDED ON SHEET 4.
- 8. CONTRACTOR SHALL VERIFY WITH THE CITY OF LEMOORE THAT NEW PROPOSED CURB AND GUTTER WILL HAVE ENOUGH SLOPE FOR PROPER DRAINAGE. ANY AREAS WHICH ARE DETERMINED TO NOT HOLD ENOUGH SLOPE WILL NEED TO BE CUT OUT UNTIL THE PROPER DRAINAGE IS ACHIEVED. ALL CURB AND GUTTER SECTIONS WILL NEED THE ENGINEER'S APPROVAL BEFORE THE PLACEMENT OF CONCRETE. QUANTITIES WILL BE PAID OUT PER UNIT COSTS AS OUTLINED IN THE BID SCHEDULE.

CINAMON DR.

WATCHLINE

MATCHLINE


SEE ABOVE LEFT

CINNAMON DR.







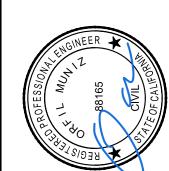

G ENGINEERS

CONSULTING ENG

PROVEMENT PLAN

OX STREET & 19TH AVENUI SHEET TITLE SHEET TITLE FOX STREET - SIDEWALK II

REVISIONS

Ö.

36_IMP FOX SIDEWALK.DWG

SCALE: 1" = 30'
JOB NO: 224-03
QA/QC: OM
FILE: 224_036




SHEET NO.




OF 26

FOX STREET

COVENTRY DRIVE SCALE: 1" = 20'

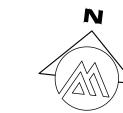

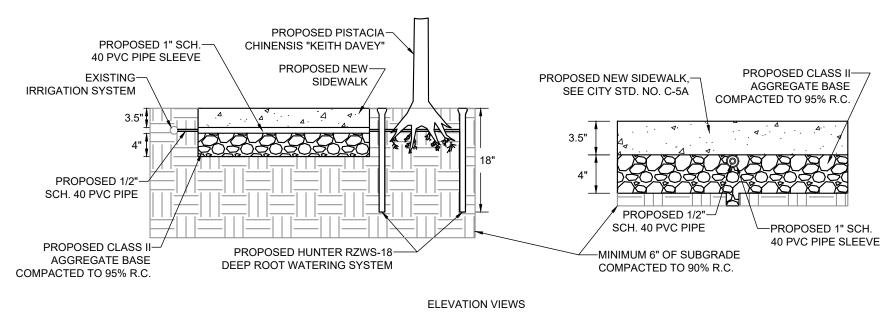

1. CLASS II AGGREGATE BASE SHALL BE EQUAL THICKNESS UNDER THE PROPOSED NEW SIDEWALK AND 1" PVC PIPE SLEEVE.

2. PROPOSED 1" PVC PIPE SLEEVE LOCATION MAY VARY DEPENDING ON PROPOSED TREE LOCATION.

DETAIL B - IRRIGATION SLEEVE N.T.S.



- 1. CONSTRUCT CONCRETE CURB & GUTTER IMPROVEMENTS PER CITY STD. NO. C-1, C-2, C-3, AND C-5A AND PER REINFORCEMENT DETAIL ON SHEET 23 AND 24.
- 2. CONSTRUCT CONCRETE SIDEWALK IMPROVEMENTS PER CITY STD. NO. C-1, C-1A, C-5A ON SHEET 23
- 3. REPAIR EXISTING IRRIGATION SYSTEM LOCATED WITHIN A 20' RADIUS OF PROPOSED CHINESE PISTACHE TREES. INSTALL PROPOSED 15 GALLON CHINESE PISTACHE 5 TO 10 FEET FROM REMOVED TREE AND/OR STUMP. INSTALL STANDARD TREE WELL PER CITY STD. NO. L-1, SEE SHEET 23.
- 4. INSTALL IRRIGATION SLEEVE UNDER PROPOSED CONCRETE SIDEWALK IMPROVEMENTS. SEE DETAIL B ON THIS SHEET.
- 5. INSTALL SIGN AND POST/MOUNTING BRACKETS. SEE SIGNAGE, STRIPING, AND MARKING PLAN ON SHEET 14, 15, AND 16.

CONTRACTOR NOTES

- 1. IT IS THE RESPONSIBILITY OF THE CONTRACTOR TO PRESERVE ALL SURVEY MONUMENTS. ANY MONUMENT DISTURBED DURING CONSTRUCTION SHALL BE PERPETUATED PER THE PROFESSIONAL LAND SURVEYOR'S ACT, BUSINESS AND PROFESSIONS CODE 8771, AT THE CONTRACTORS EXPENSE.
- 2. LOCATIONS OF EXISTING UTILITIES ARE APPROXIMATED. CONTRACTOR TO FIELD VERIFY ALL EXISTING UTILITIES BEFORE COMMENCEMENT OF WORK.
- 3. CONTRACTOR TO OFFSET THE PLANTING HOLE OF PROPOSED CHINESE PISTACHE A DISTANCE OF 5 TO 10 FEET FROM THE REMOVED TREE AND/OR STUMP.

GENERAL CONCRETE NOTES

- 1. ALL CONCRETE SHALL BE A MINIMUM OF 5 SACK MIX AND TEST TO A MINIMUM OF 3200 PSI IN 28 DAYS.
- 2. NO CROSS SLOPE IN THE PATH OF TRAVEL SHALL EXCEED 1.5%.
- 3. SIDEWALKS SHALL HAVE A LIGHT BROOM FINISH. ALL BROOMING SHALL BE PARALLEL TO THE DIRECTION OF FLOW.
- 4. ALL WORK CONSIDERED BY THESE PLANS SHALL BE IN COMPLIANCE WITH A.D.A. REGULATIONS.
- 5. WHEN MAXIMUM DAYTIME TEMPERATURE EXCEEDS 50°F, ALL NEWLY PLACED CONCRETE SHALL BE SPRAYED UNIFORMLY WITH A CURING COMPOUND. CURING COMPOUND SHALL BE APPLIED AT A NOMINAL RATE OF ONE GALLON PER 150 S.F., UNLESS OTHERWISE SPECIFIED.
- 6. CONTRACTOR SHALL BE RESPONSIBLE FOR DOWELING INTO ADJACENT CONCRETE IN ORDER TO CONNECT NEW CONCRETE WORK WITH EXISTING.
- 7. CONTRACTOR SHALL SAWCUT AND REMOVE 2' OF ASPHALT PAVEMENT IN FRONT OF REPLACED CURB & GUTTER IN ORDER TO PROPERLY FIT THE CONCRETE FORMS. ASPHALT PATCH SHALL BE MADE PER TYPICAL REPAIR DETAIL 1 AND 2, PROVIDED ON SHEET 4.
- 8. CONTRACTOR SHALL VERIFY WITH THE CITY OF LEMOORE THAT NEW PROPOSED CURB AND GUTTER WILL HAVE ENOUGH SLOPE FOR PROPER DRAINAGE. ANY AREAS WHICH ARE DETERMINED TO NOT HOLD ENOUGH SLOPE WILL NEED TO BE CUT OUT UNTIL THE PROPER DRAINAGE IS ACHIEVED. ALL CURB AND GUTTER SECTIONS WILL NEED THE ENGINEER'S APPROVAL BEFORE THE PLACEMENT OF CONCRETE. QUANTITIES WILL BE PAID OUT PER UNIT COSTS AS OUTLINED IN THE BID SCHEDULE.







FOX








SHEET NO.

SEE BELOW RIGHT

THE PROPERTY OF THE PROPERTY



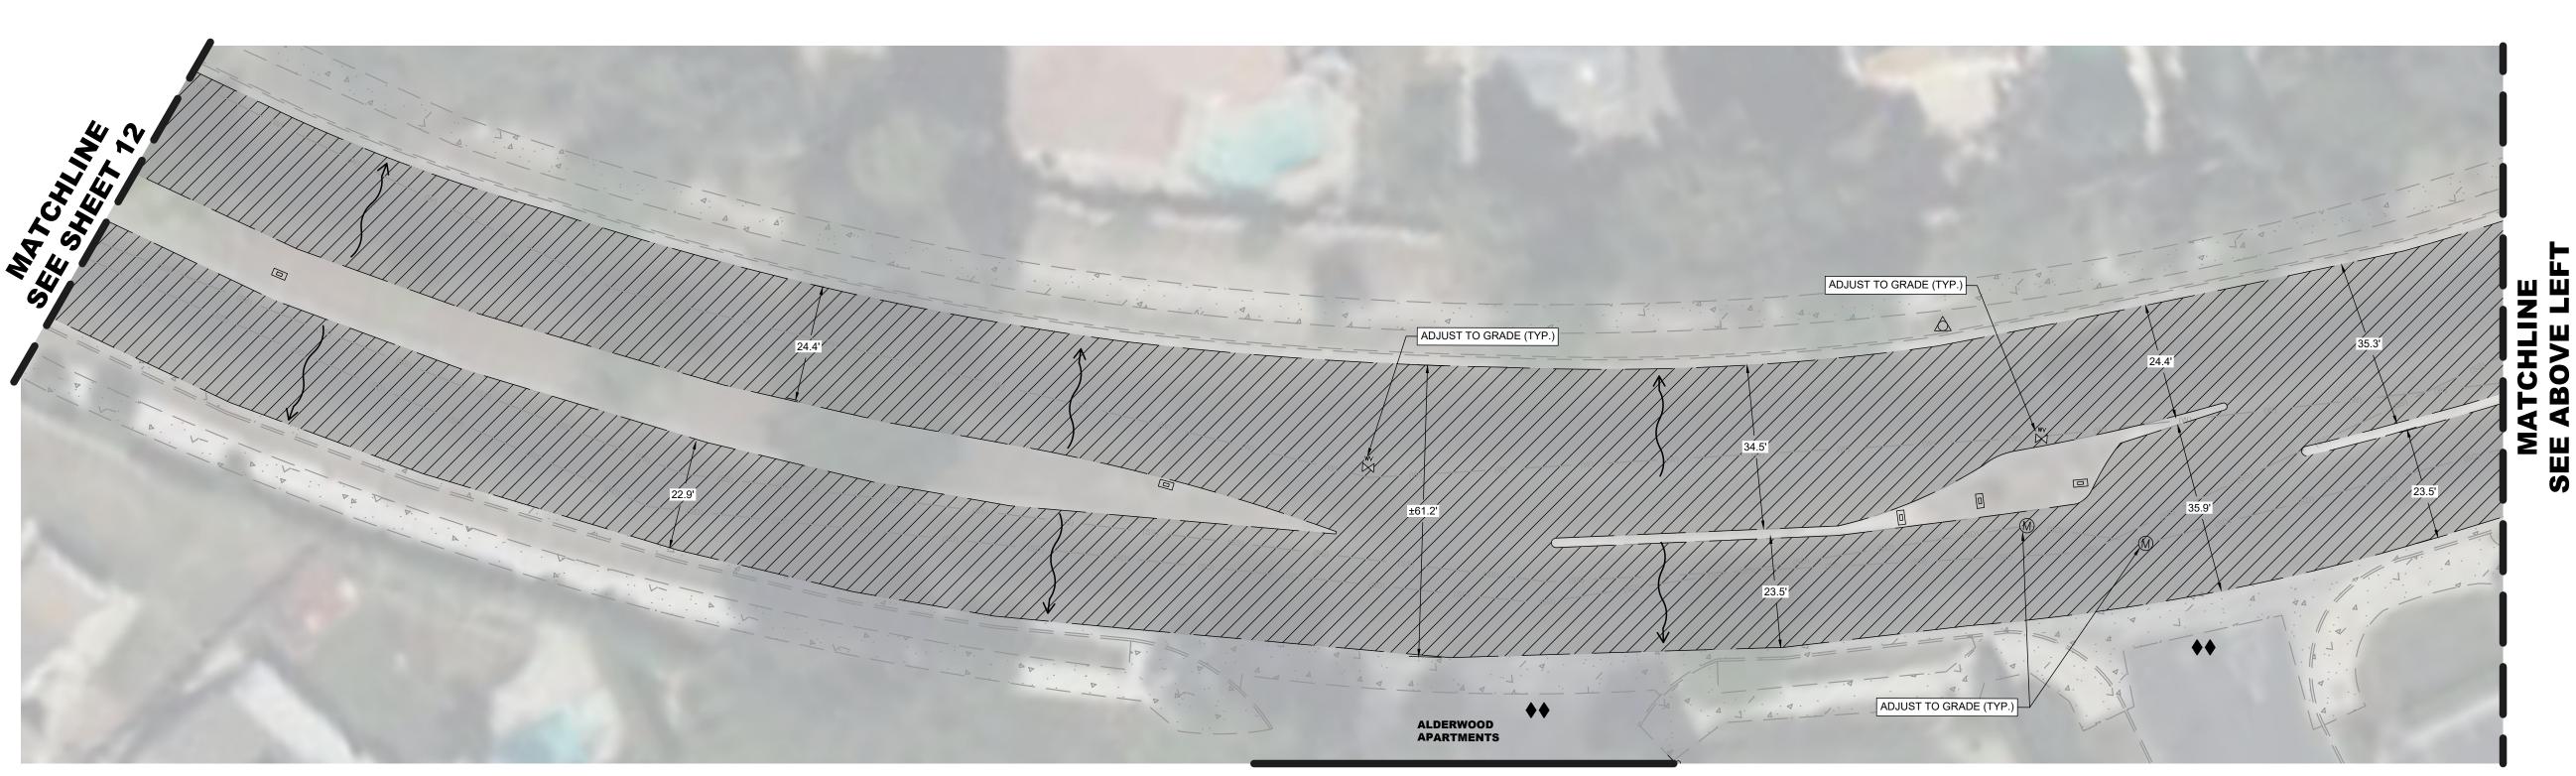

LEGEND

EXISTING CONCRETE FACILITIES

REMOVE AND REPLACE 0.30' HMA TYPE A OVER EXISTING AGGREGATE BASE COMPACTED 12" AT 95% RELATIVE COMPACTION.



LIMITS OF TYPE II (0.15 TO 0.20%) FIBERIZED MICRO-SURFACE PAVEMENT TREATMENT WITH BLACK ROCK



EXISTING DRAINAGE FLOW DIRECTION



SEE TYPICAL HMA TRANSITION DETAIL ON SHEET 12
SEE CROSS GUTTER HMA TRANSITION DETAIL ON SHEET 12

SEE TYPICAL MICRO-SURFACING TRANSITION DETAIL 1 ON

CONSTRUCTION NOTES

1. REPLACE EXISTING LOOP DETECTOR TYPE E SYSTEM, SEE SHEET 24 FOR DETAILS. REFERENCE ES-1C, ES-5D, ES 5-A, ES-5B WHERE APPLICABLE.





PEMBROOK LN.

CONTRACTOR OVERLAY IMPROVEMENT NOTES
SEE SHEET 2







FOX STREET
SCALE: 1" = 20'

BRENTWOOD DR.

LEGEND


EXISTING CONCRETE FACILITIES

REMOVE AND REPLACE 0.30' HMA TYPE A OVER EXISTING AGGREGATE BASE COMPACTED 12" AT 95% RELATIVE

EXISTING DRAINAGE FLOW DIRECTION SEE TYPICAL HMA TRANSITION DETAIL ON THIS SHEET SEE CROSS GUTTER HMA TRANSITION DETAIL ON THIS SHEET

CONTRACTOR OVERLAY IMPROVEMENT NOTES


SEE SHEET 2

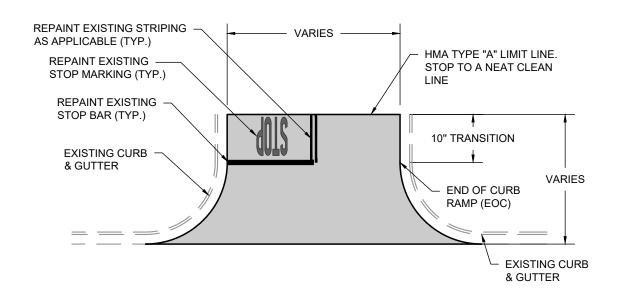

- 1. HMA TYPE "A" TO EXTEND 10' BEYOND THE END OF RAMP AS SHOWN BELOW.
- 2. IF PAVEMENT STRIPING & MARKINGS (CROSSWALKS, STOP BARS, STOP MARKING LEGENDS, CENTERLINE, ECT.) EXIST, THEN THEY SHALL BE REPAINTED WHEN DISTURBED BY HMA UNLESS SPECIFIED OTHERWISE ON PLANS.


TYPICAL HMA TRANSITION DETAIL

N.T.S.

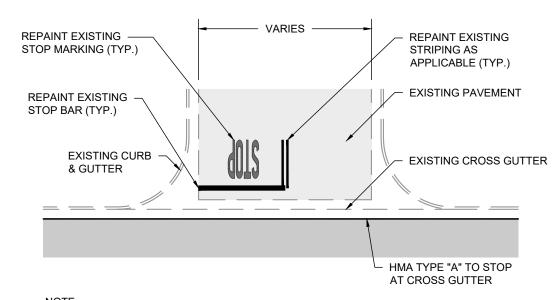

- 1. HMA TYPE "A" TO STOP AT CROSS GUTTER AS SHOWN BELOW.
- 2. IF PAVEMENT STRIPING & MARKINGS (CROSSWALKS, STOP BARS, STOP MARKING LEGENDS, CENTERLINE, ECT.) EXIST, THEN THEY SHALL BE REPAINTED WHEN ADJACENT TO CROSS GUTTER UNLESS SPECIFIED OTHERWISE ON PLANS.

CROSS GUTTER HMA TRANSITION DETAIL N.T.S.

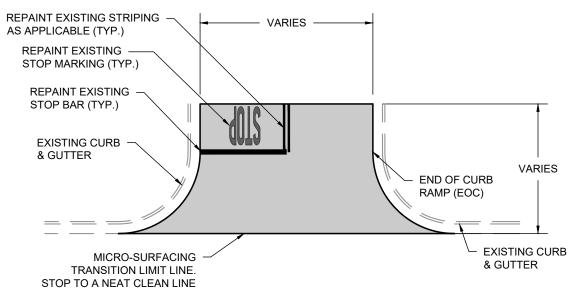


- 1. MIRCO-SURFACING PAVEMENT TREATMENT TO EXTEND 10' BEYOND THE END OF RAMP AS
- 2. IF PAVEMENT STRIPING & MARKINGS (CROSSWALKS, STOP BARS, STOP MARKING LEGENDS, CENTERLINE, ECT.) EXIST, THEN THEY SHALL BE REPAINTED WHEN DISTURBED BY MICRO-SURFACING TREATMENT UNLESS SPECIFIED OTHERWISE ON PLANS.


TYPICAL MICRO-SURFACING **TRANSITION DETAIL 1**

N.T.S.





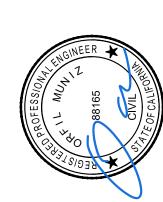

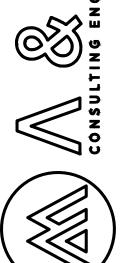

CITY OF LEMOORE
19TH AVENUE ROADWAY STREET FOX



SHEET NO.



KEYNOTE LEGEND

1 PROTECT IN PLACE EXISTING MANHOLE COVER 2 PROTECT IN PLACE EXISTING VALVE COVER PROTECT IN PLACE EXISTING SIGNS AND POST 4 PROTECT IN PLACE EXISTING UTILITY BOX

5 PROTECT IN PLACE EXISTING CURB DRAIN INLET 6 PROTECT IN PLACE EXISTING MONUMENT


LEGEND

EXISTING CONCRETE FACILITIES LIMITS OF TYPE II (0.15 TO 0.20%) FIBERIZED MICRO-SURFACE PAVEMENT TREATMENT WITH BLACK ROCK SEE TYPICAL MICRO-SURFACING TRANSITION DETAIL 1 ON SHEET 12 SEE TYPICAL MICRO-SURFACING TRANSITION DETAIL 2 BELOW SEE CROSS GUTTER MICRO-SURFACING TRANSITION DETAIL BELOW

DRAIN DIRECTION TO MATCH EXISTING CROSS SLOPE


ESTIMATED QUANTITIES (BASE BID)				
ROAD NAME	APPROX. LENGTH (FT)	AVERAGE WIDTH (FT)	AREA	
	. ,		SF	SY
FOX STREET	1467	57	85,554	9,506
		TOTAL	85,554	9,506

MICRO-SURFACING SPREAD RATES			
ТҮРЕ	LOCATION	RANGE (LB OF DRY AGGREGATE/ SQ YD)	
TYPE II, 0.15-0.20% FIBERIZED MICRO SURFACING (BLACK ROCK)	FULL LANE WIDTH	10 - 20	

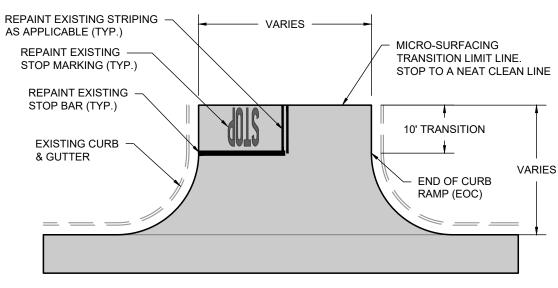

- 1. MIRCO-SURFACING PAVEMENT TREATMENT TO EXTEND 10' BEYOND THE END OF RAMP AS
- 2. IF PAVEMENT STRIPING & MARKINGS (CROSSWALKS, STOP BARS, STOP MARKING LEGENDS, CENTERLINE, ECT.) EXIST, THEN THEY SHALL BE REPAINTED WHEN DISTURBED BY MICRO-SURFACING TREATMENT UNLESS SPECIFIED OTHERWISE ON PLANS.

TYPICAL MICRO-SURFACING **TRANSITION DETAIL 2** N.T.S.

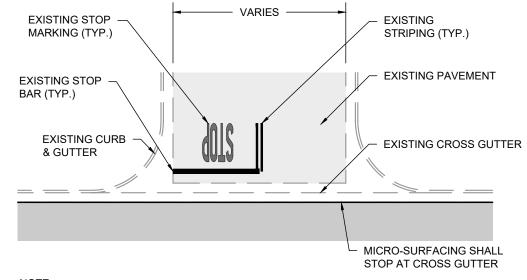


- 1. MICRO-SURFACING PAVEMENT TREATMENT TO STOP AT CROSS GUTTER AS SHOWN BELOW.
- 2. IF PAVEMENT STRIPING & MARKINGS (CROSSWALKS, STOP BARS, STOP MARKING LEGENDS, CENTERLINE, ECT.) EXIST, THEN THEY SHALL BE REPAINTED WHEN ADJACENT TO CROSS GUTTER UNLESS SPECIFIED OTHERWISE ON PLANS.


CROSS GUTTER MICRO-SURFACING TRANSITION DETAIL N.T.S.





FOX STREET
SCALE: 1" = 100'

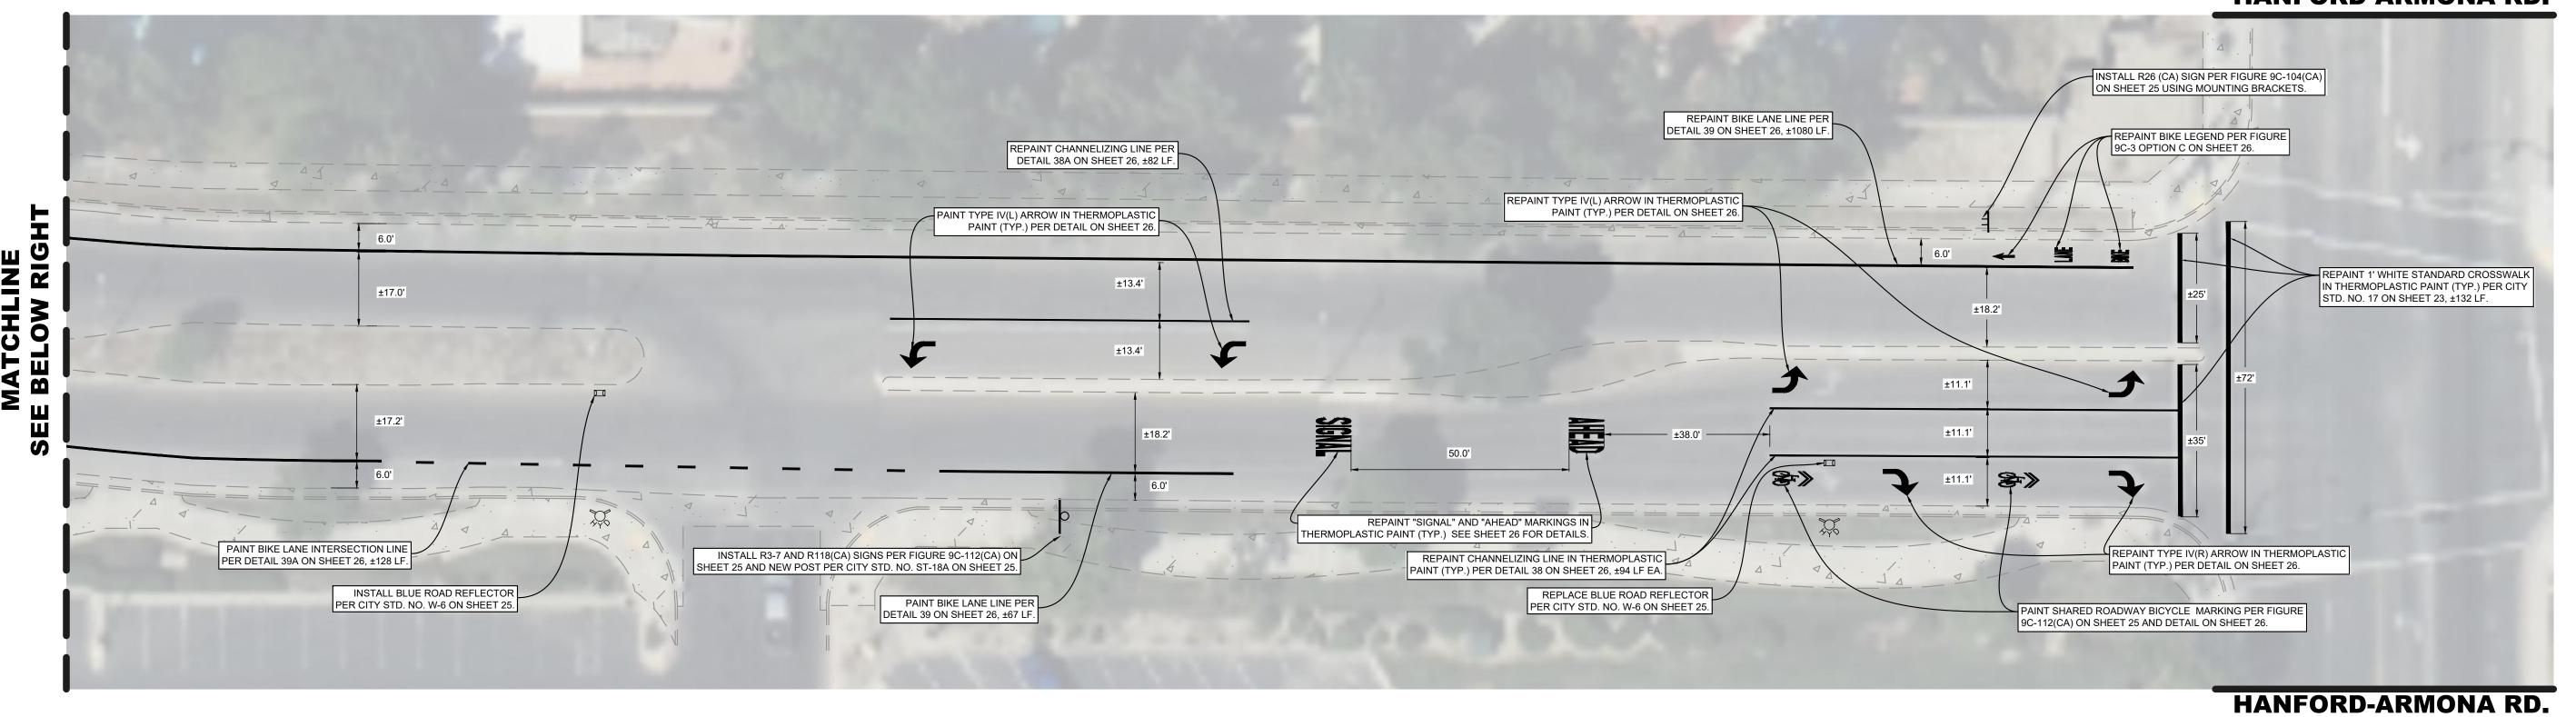

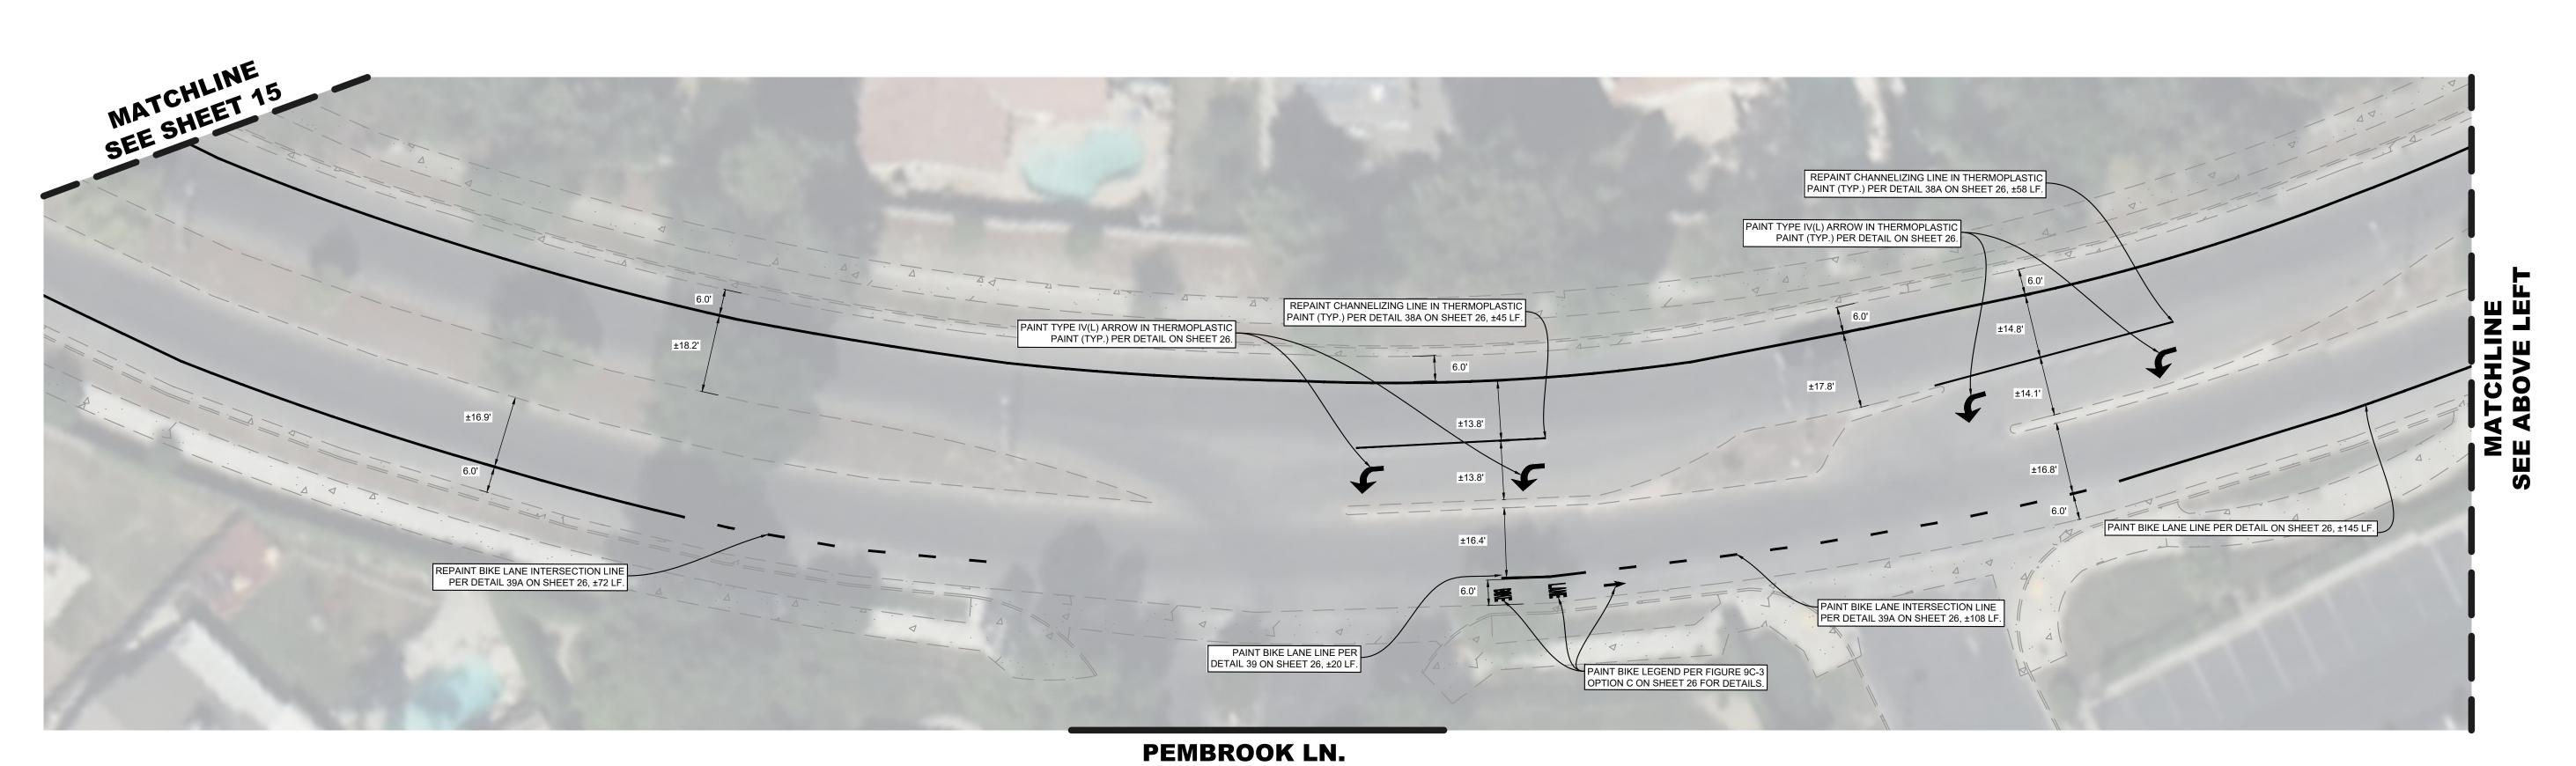

FOX STREET
SCALE: 1" = 20'











SIGNING, STRIPING & MARKING NOTES

LEGEND

SEE SHEET 2

CONTRACTOR STRIPING NOTES

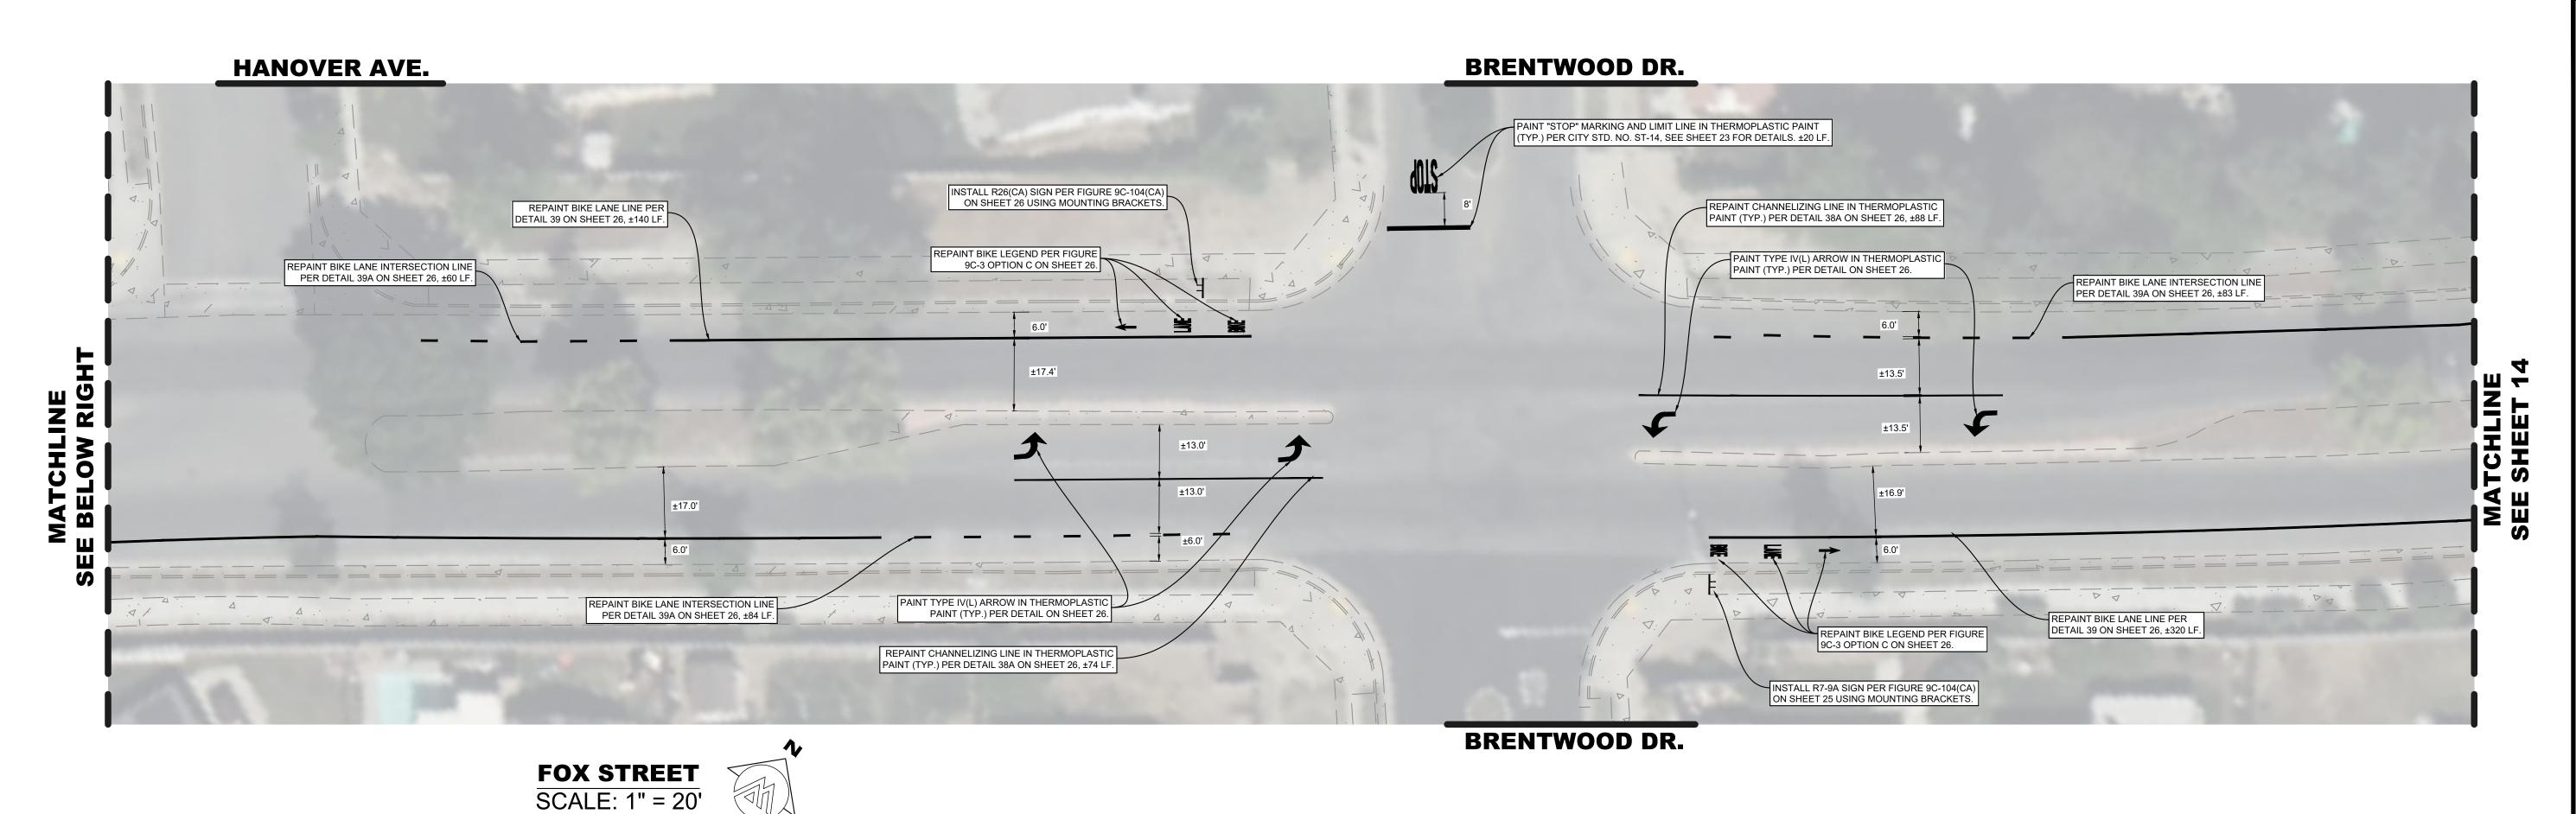

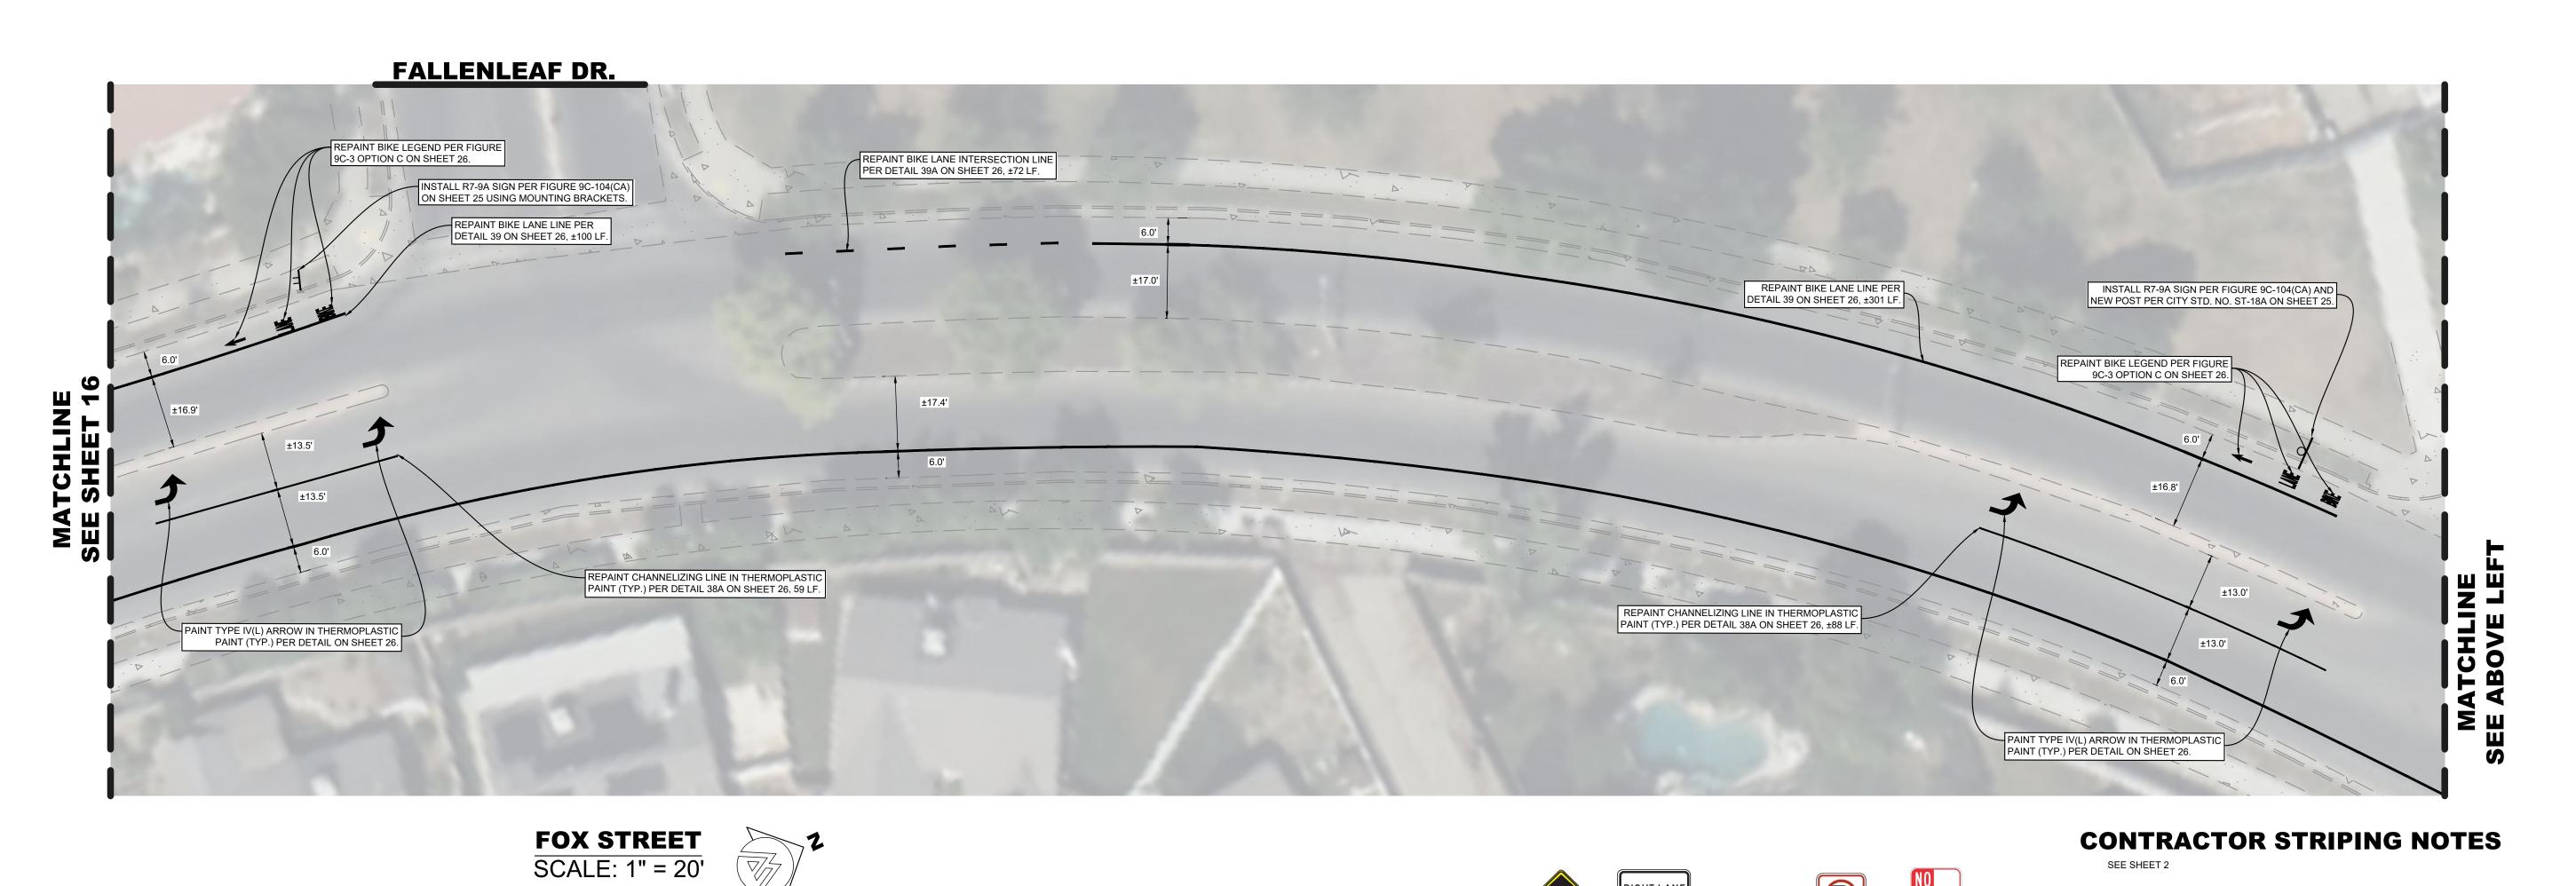














SEE SHEET 2

LEGEND

SEE SHEET 2

SIGNING, STRIPING & MARKING NOTES SEE SHEET 2

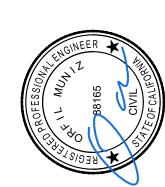

CITY OF LEMOORE
19TH AVENUE ROADWAY STREET FOX



SHEET NO.

15

FOX STREET SCALE: 1" = 20'

SIGNING, STRIPING & MARKING NOTES

CONTRACTOR STRIPING NOTES

SEE SHEET 2.

LEGEND













PROPOSED SIGNS N.T.S.

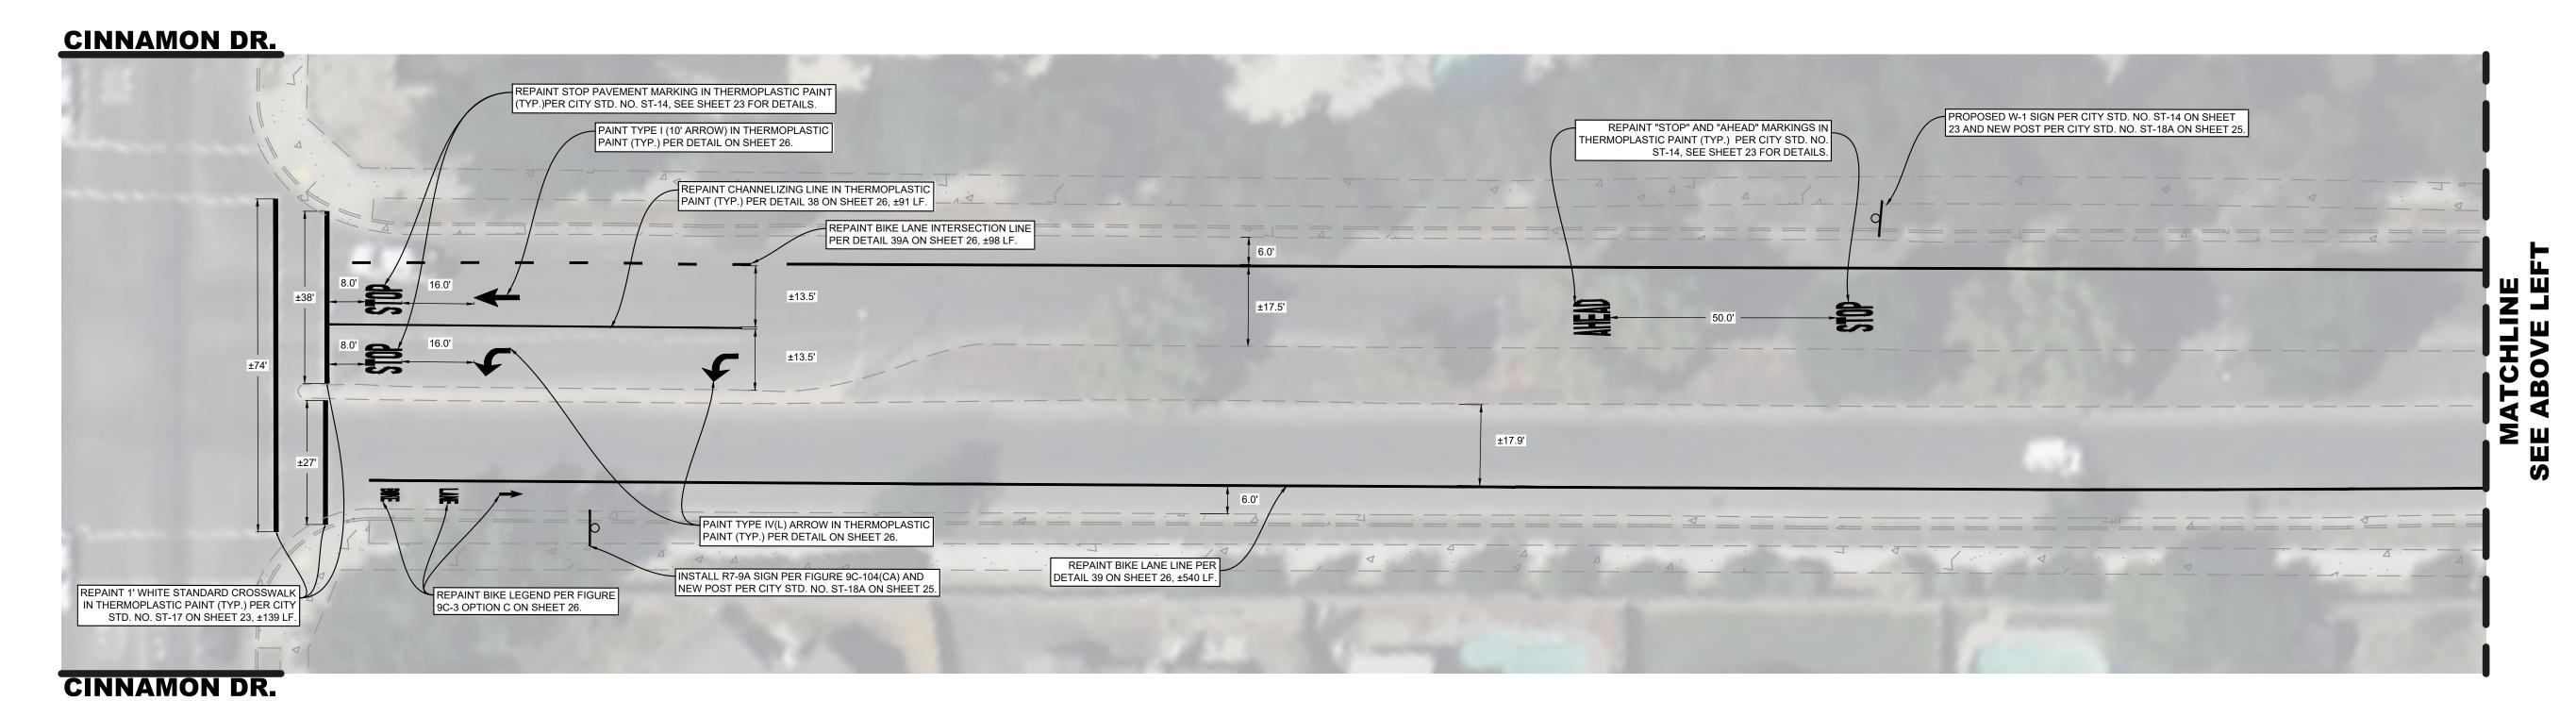

FOX STREET
SCALE: 1" = 20'




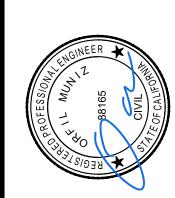

FOX



19TH AVENUE , SCALE 1" = 20'

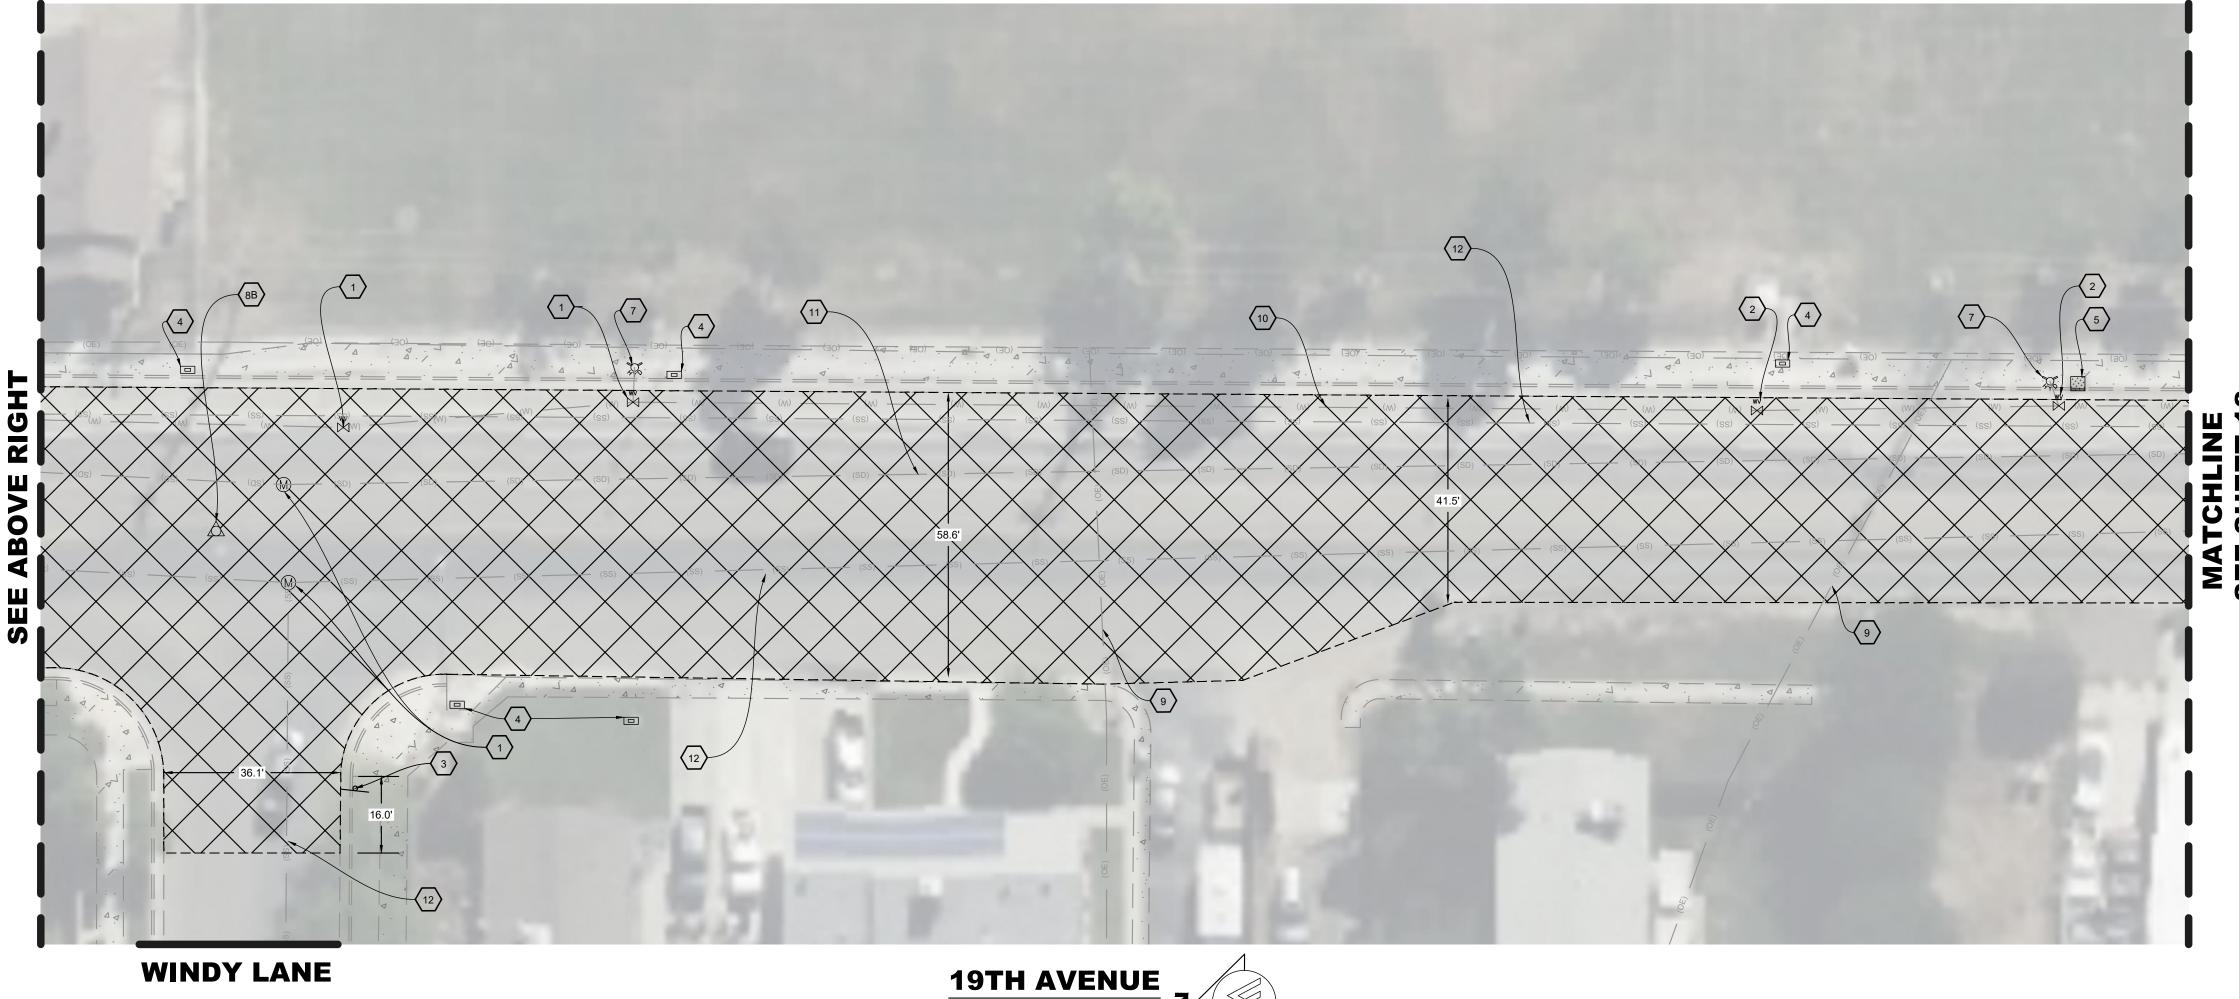

SCALE 1" = 20'

DEMOLITION NOTES

1. PROTECT IN PLACE EXISTING MANHOLE.

2. PROTECT IN PLACE EXISTING WATER VALVE.

3. PROTECT IN PLACE EXISTING SIGNS AND POST.

4. PROTECT IN PLACE EXISTING UTILITY BOX.

5. PROTECT IN PLACE EXISTING CURB DRAIN INLET.

6. PROTECT IN PLACE GUY WIRE.

7. PROTECT IN PLACE FIRE HYDRANT

8A) PROTECT IN PLACE EXISTING MONUMENT - 1.25" IRON PIPE, 0.85' DP - L.S. 4375, PER PM 11-06

8B. PROTECT IN PLACE EXISTING MONUMENT - 0.5" REBAR, 0.5' DP - L.S. 4375, PER PM 11-06

9. PROTECT IN PLACE EXISTING OVERHEAD ELECTRICITY

10. PROTECT IN PLACE EXISTING WATERLINE

11.) PROTECT IN PLACE EXISTING STORM DRAIN SEWER LINE

12. PROTECT IN PLACE EXISTING SANITARY SEWER LINE

CONTRACTOR DEMOLITION NOTES

SEE SHEET 2

LEGEND


SEE SHEET 2

ESTIMATED QUANTITIES OF GRIND

ROAD NAME	APPROX. LENGTH (FT)	AVERAGE WIDTH (FT)	AREA	
			SF	SY
19TH AVENUE	1500	55	79,895	8,880
		TOTAL	79,895	8,880

OVERHEAD POWER LINES



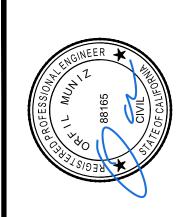








19TH AVENUE SCALE: 1" = 20'

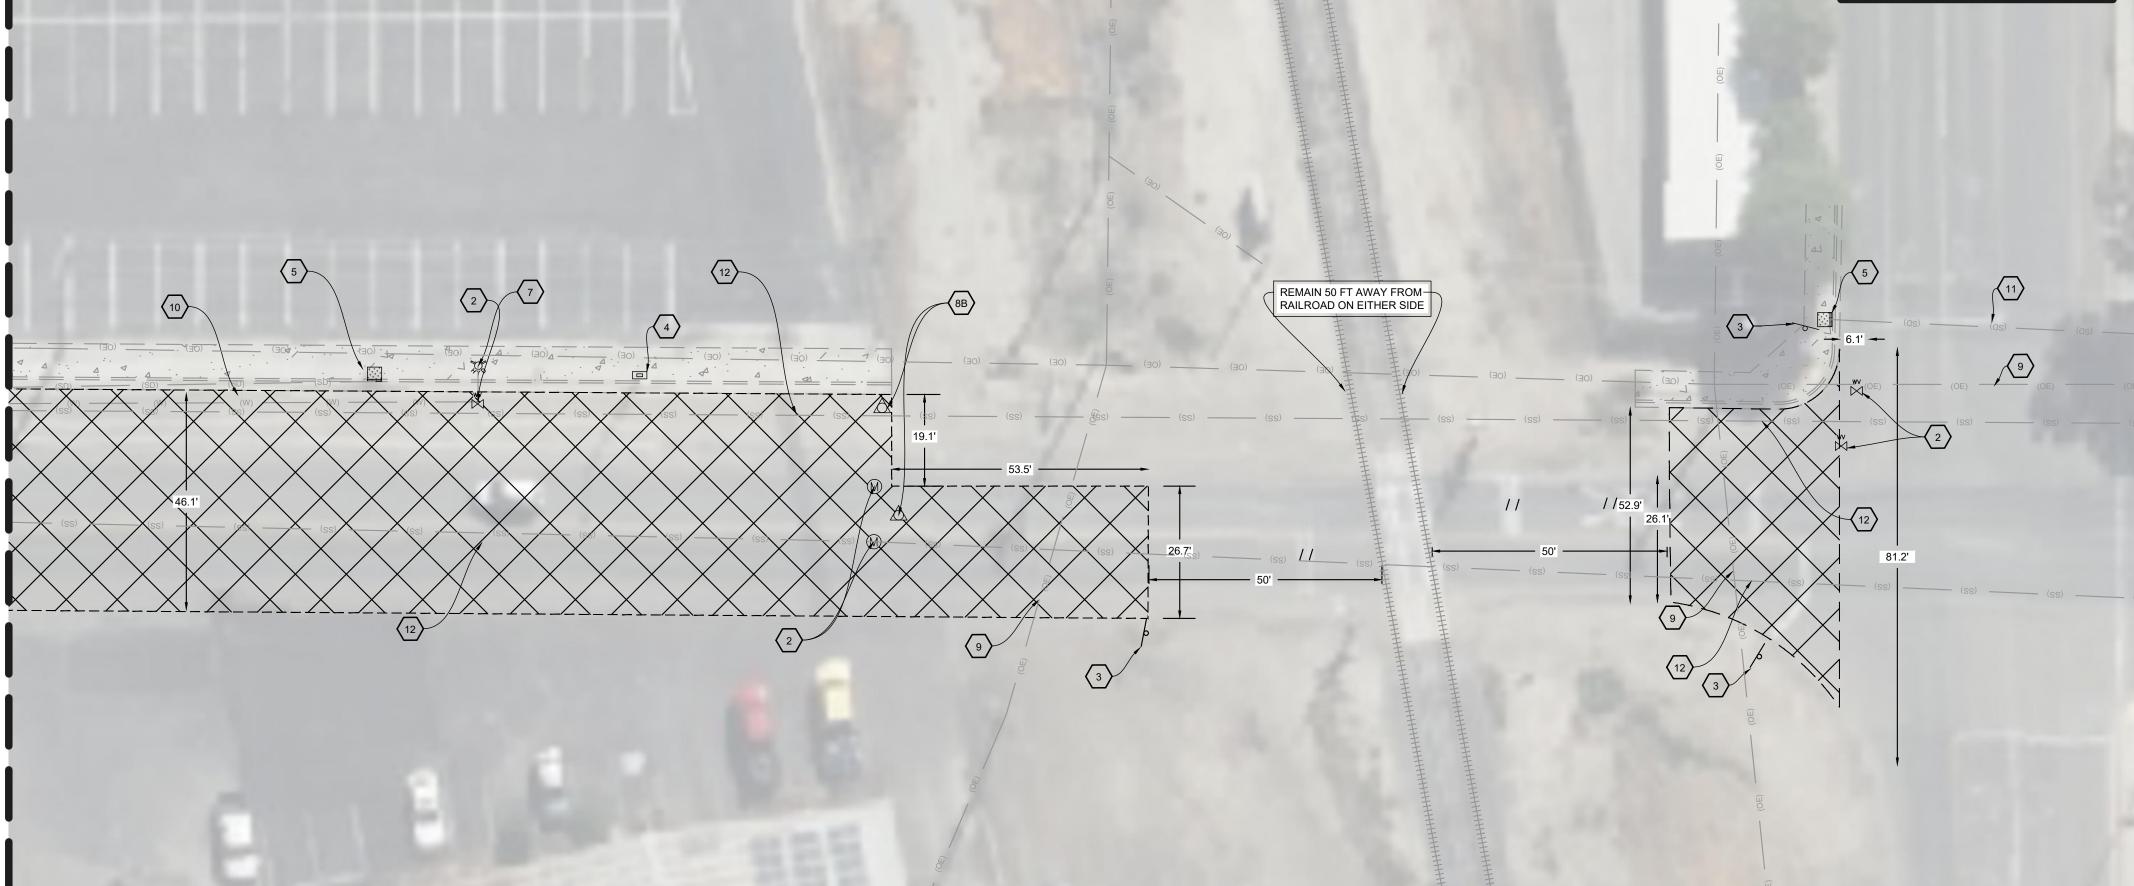

19TH AVENUE

SCALE: 1" = 20'



1. PROTECT IN PLACE EXISTING MANHOLE.

2. PROTECT IN PLACE EXISTING WATER VALVE.

3. PROTECT IN PLACE EXISTING SIGNS AND POST.

4. PROTECT IN PLACE EXISTING UTILITY BOX.

5. PROTECT IN PLACE EXISTING CURB DRAIN INLET.

6. PROTECT IN PLACE GUY WIRE.

7. PROTECT IN PLACE FIRE HYDRANT

8A.) PROTECT IN PLACE EXISTING MONUMENT - 1.25" IRON PIPE, 0.85' DP - L.S. 4375, PER PM 11-06

9. PROTECT IN PLACE EXISTING OVERHEAD ELECTRICITY

10) PROTECT IN PLACE EXISTING WATERLINE

11.) PROTECT IN PLACE EXISTING STORM DRAIN SEWER LINE

12. PROTECT IN PLACE EXISTING SANITARY SEWER LINE

CONTRACTOR DEMOLITION NOTES

SEE SHEET 2


LEGEND

SEE SHEET 2

D STREET

D STREET

ESTIMATED QUANTITIES OF GRIND

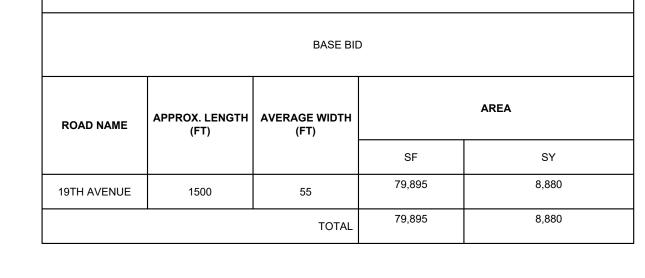











SHEET NO.

18

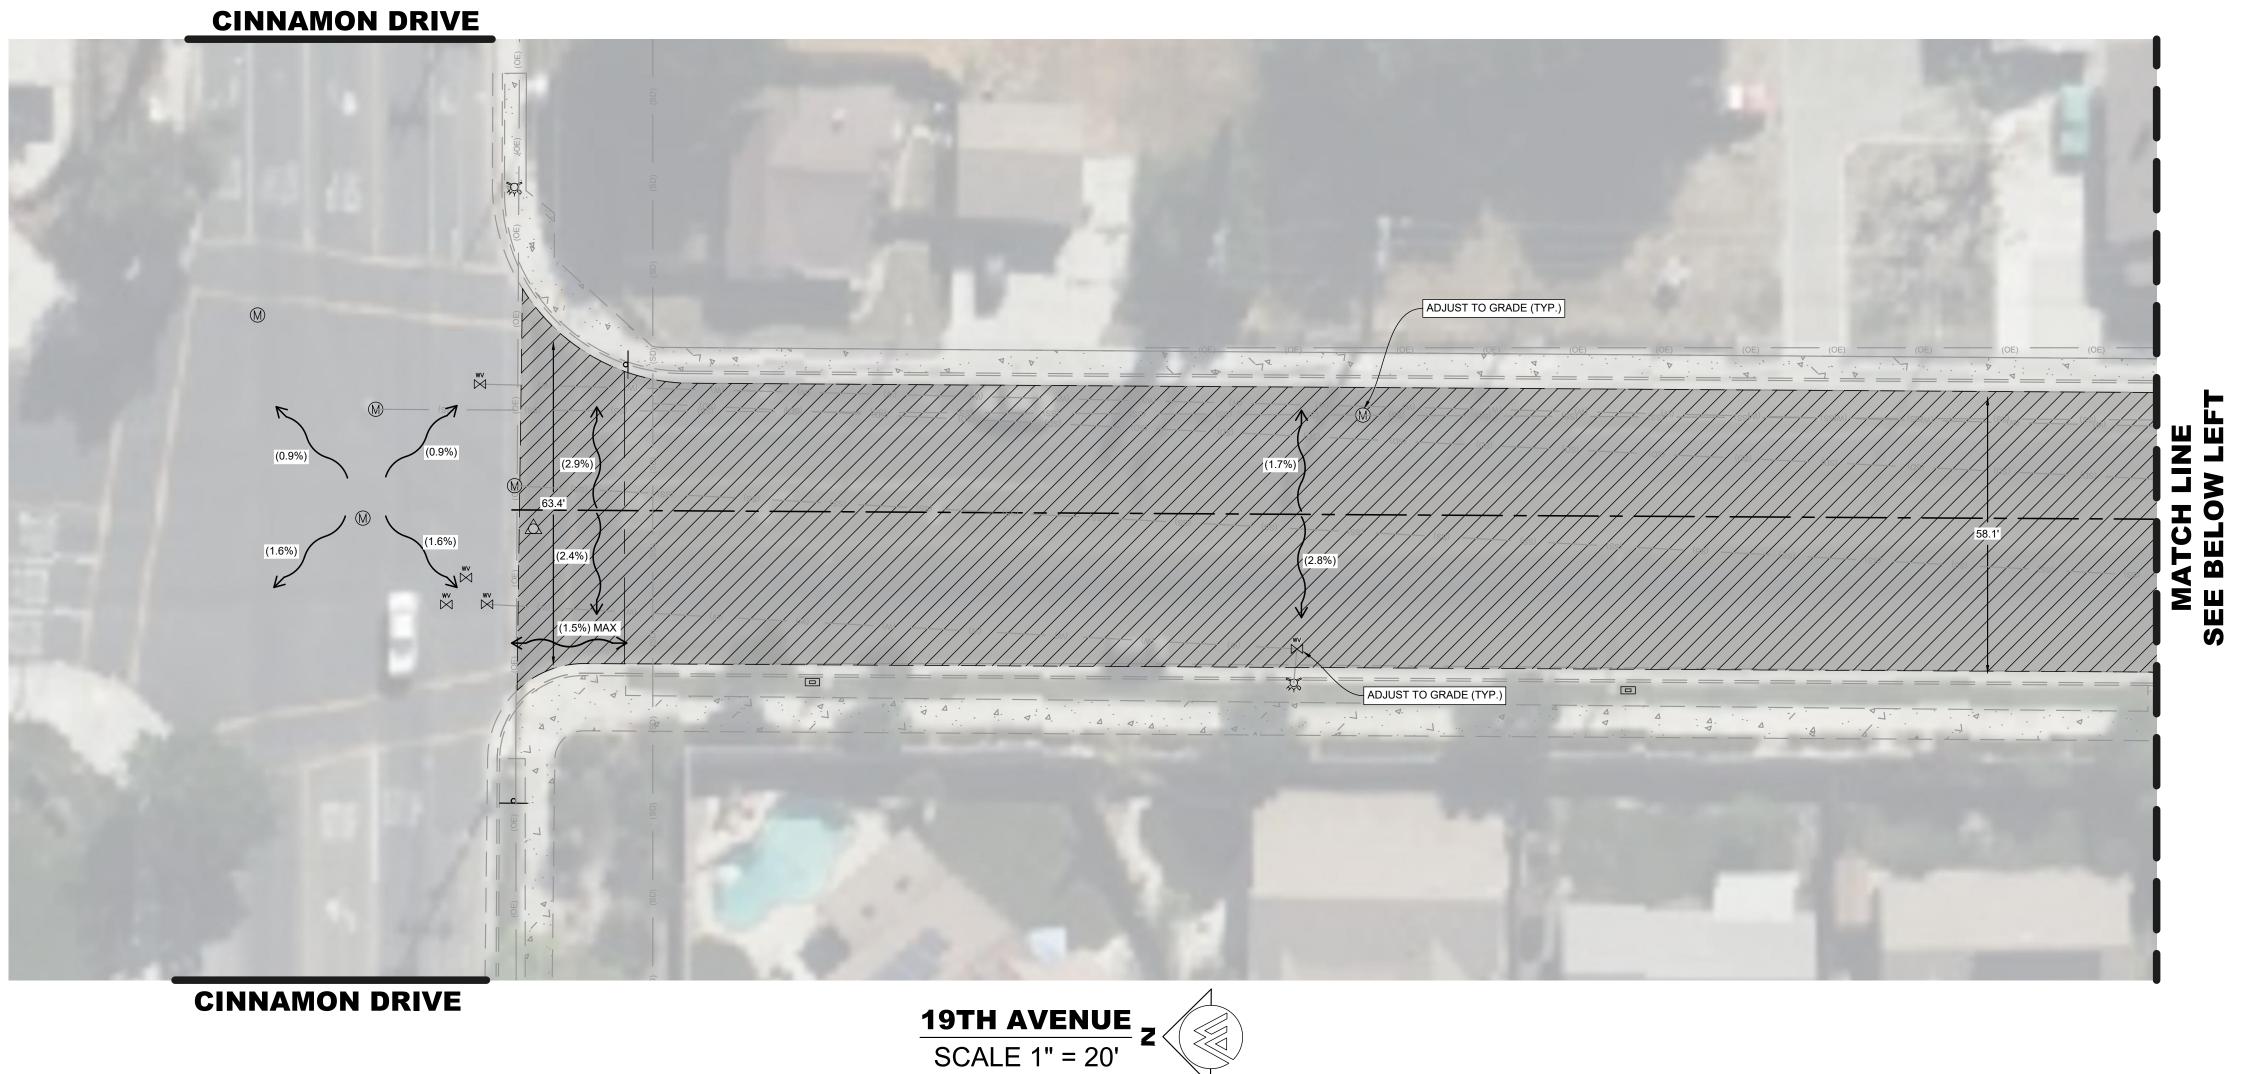

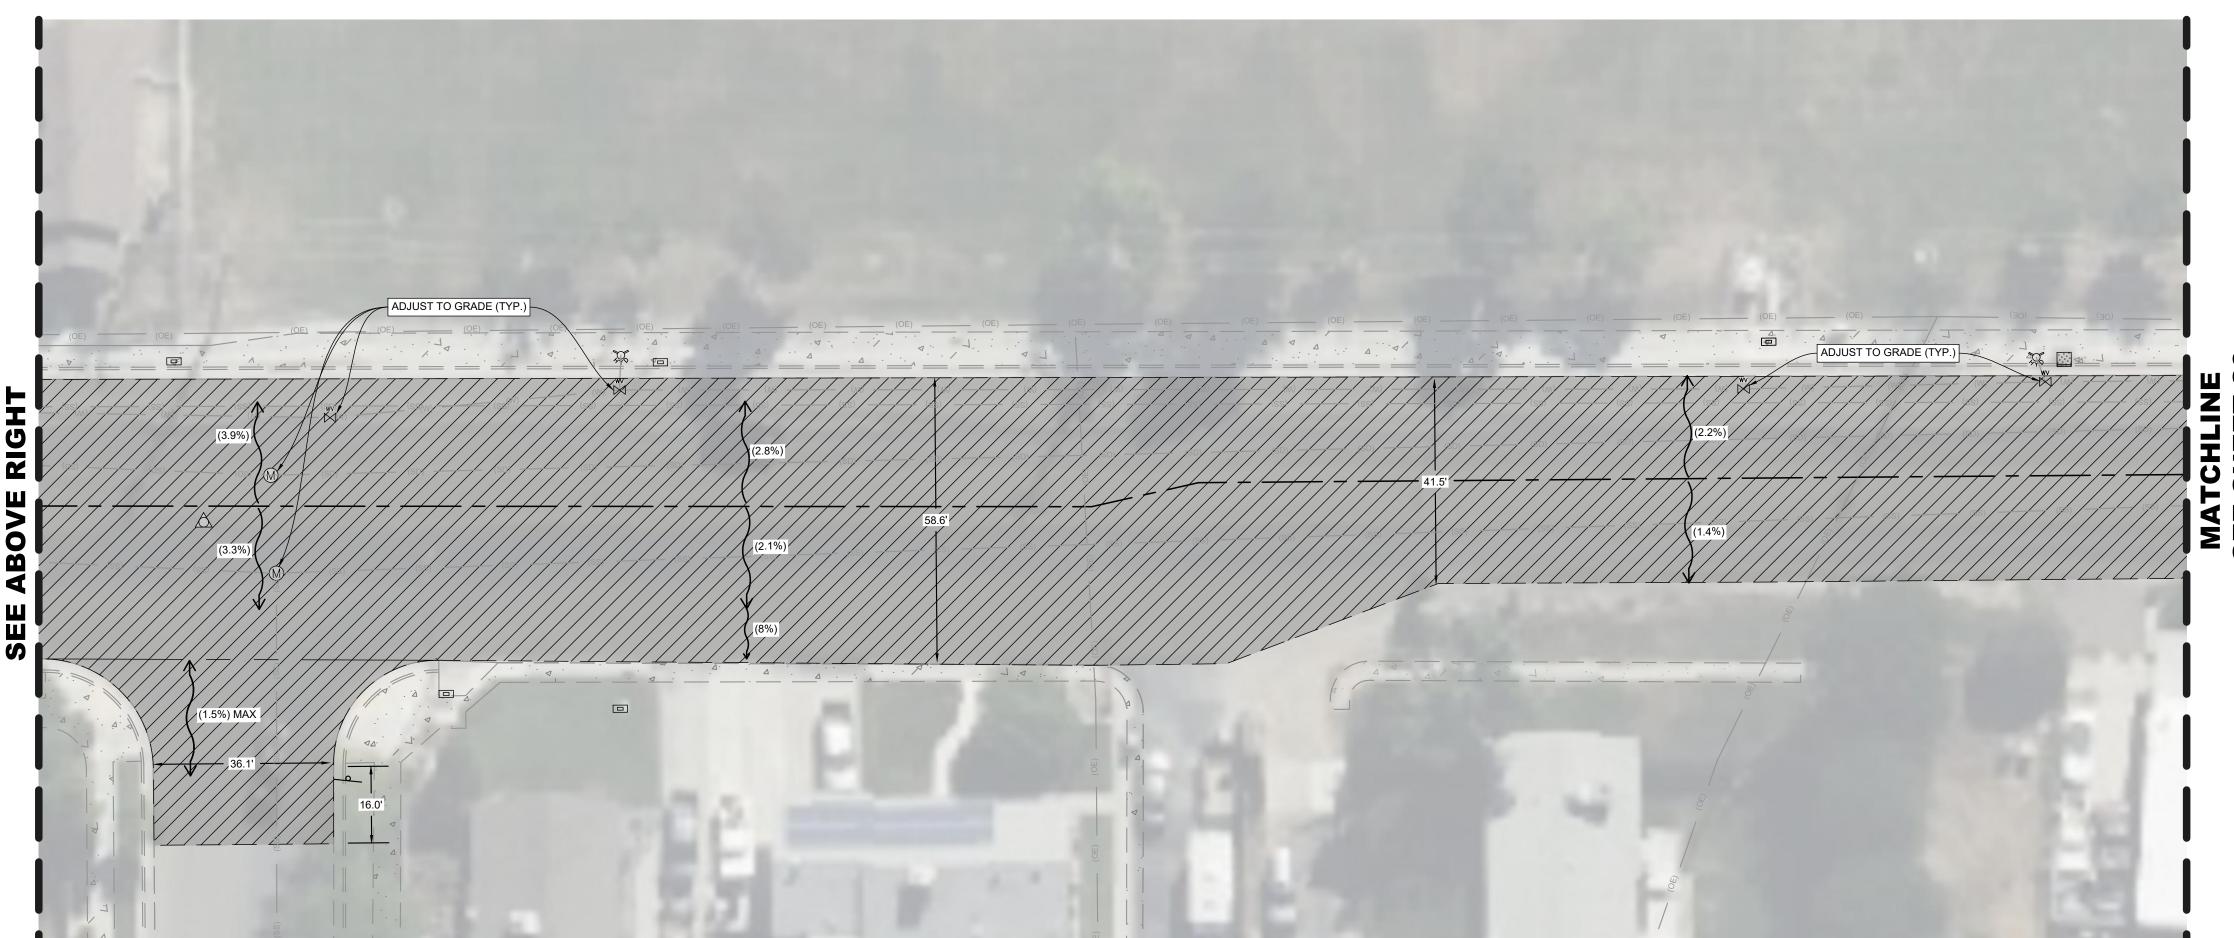

LEGEND

EXISTING CONCRETE FACILITIES



REMOVE AND REPLACE 0.30' HMA TYPE A OVER EXISTING AGGREGATE BASE COMPACTED 12" AT 95% RELATIVE



EXISTING DRAINAGE FLOW DIRECTION

CONTRACTOR OVERLAY IMPROVEMENT NOTES


SEE SHEET 2

ESTIMATED QUANTITIES OF OVERLAY

BASE BID APPROX. LENGTH | AVERAGE WIDTH 19TH AVENUE TOTAL

CITY OF LEMOORE
19TH AVENUE ROADWAY

19TH AVENU

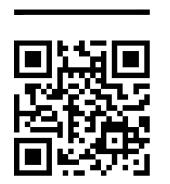

SHEET NO.

19



WINDY LANE

19TH AVENUE 2 SCALE: 1" = 20'

D STREET REMAIN 50 FT AWAY FROM RAILROAD ON EITHER SIDE ADJUST TO GRADE (TYP.) ADJUST TO GRADE (TYP.)

19TH AVENUE SCALE: 1" = 20'

LEGEND

EXISTING CONCRETE FACILITIES



REMOVE AND REPLACE 0.30' HMA TYPE A OVER EXISTING AGGREGATE BASE COMPACTED 12" AT 95% RELATIVE



EXISTING DRAINAGE FLOW DIRECTION

CONTRACTOR OVERLAY IMPROVEMENT NOTES

SEE SHEET 2

MATCHLINE SEE BELOW LEF

ESTIMATED QUANTITIES OF OVERLAY

BASE BID APPROX. LENGTH | AVERAGE WIDTH 19TH AVENUE

TOTAL

CITY OF LEMOORE
19TH AVENUE ROADWAY



SHEET NO.

D STREET





SEE SHEET 2

CONTRACTOR STRIPING NOTES

SEE SHEET 2

SIGNING, STRIPING & MARKING NOTES

MAY USE R3-7

(N.T.S.)

R118 (CA) **PROPOSED SIGNS**

EXCEPT

REPAINT FACE AND TOP-OF CURB RED ±25 LF REPAINT FACE AND TOP REPAINT FACE AND TOP OF CURB RED ±85 LF OF CURB RED ±100 LF MATCHLINE SEE SHEET 22 REPLACE BLUE ROAD REFLECTOR PER CITY STD. NO. W-6 IN SHEET 25 REPAINT BIKE LANE LINE PER DETAIL 39 IN SHEET 26 ±765 LF INSTALL BLUE ROAD REFLECTOR PER CITY STD. NO W-6 IN SHEET 25 ullet REPAINT CENTERLINE MARKING PER ulletDETAIL 32 IN SHEET 26 ±410 LF EA. REPAINT LIMIT LINE PER CITY STD. NO. ST-14. SEE SHEET 23 FOR DETAILS PAINT SHARED ROADWAY BICYCLE MARKING PER DETAIL IN SHEET 26 PAINT STOP PAVEMENT MARKING PER CITY STD. NO. ST-14, SEE SHEET 23 FOR DETAILS




SHEET NO.

WINDY LANE

SCALE: 1" = 20'

19TH AVENUE

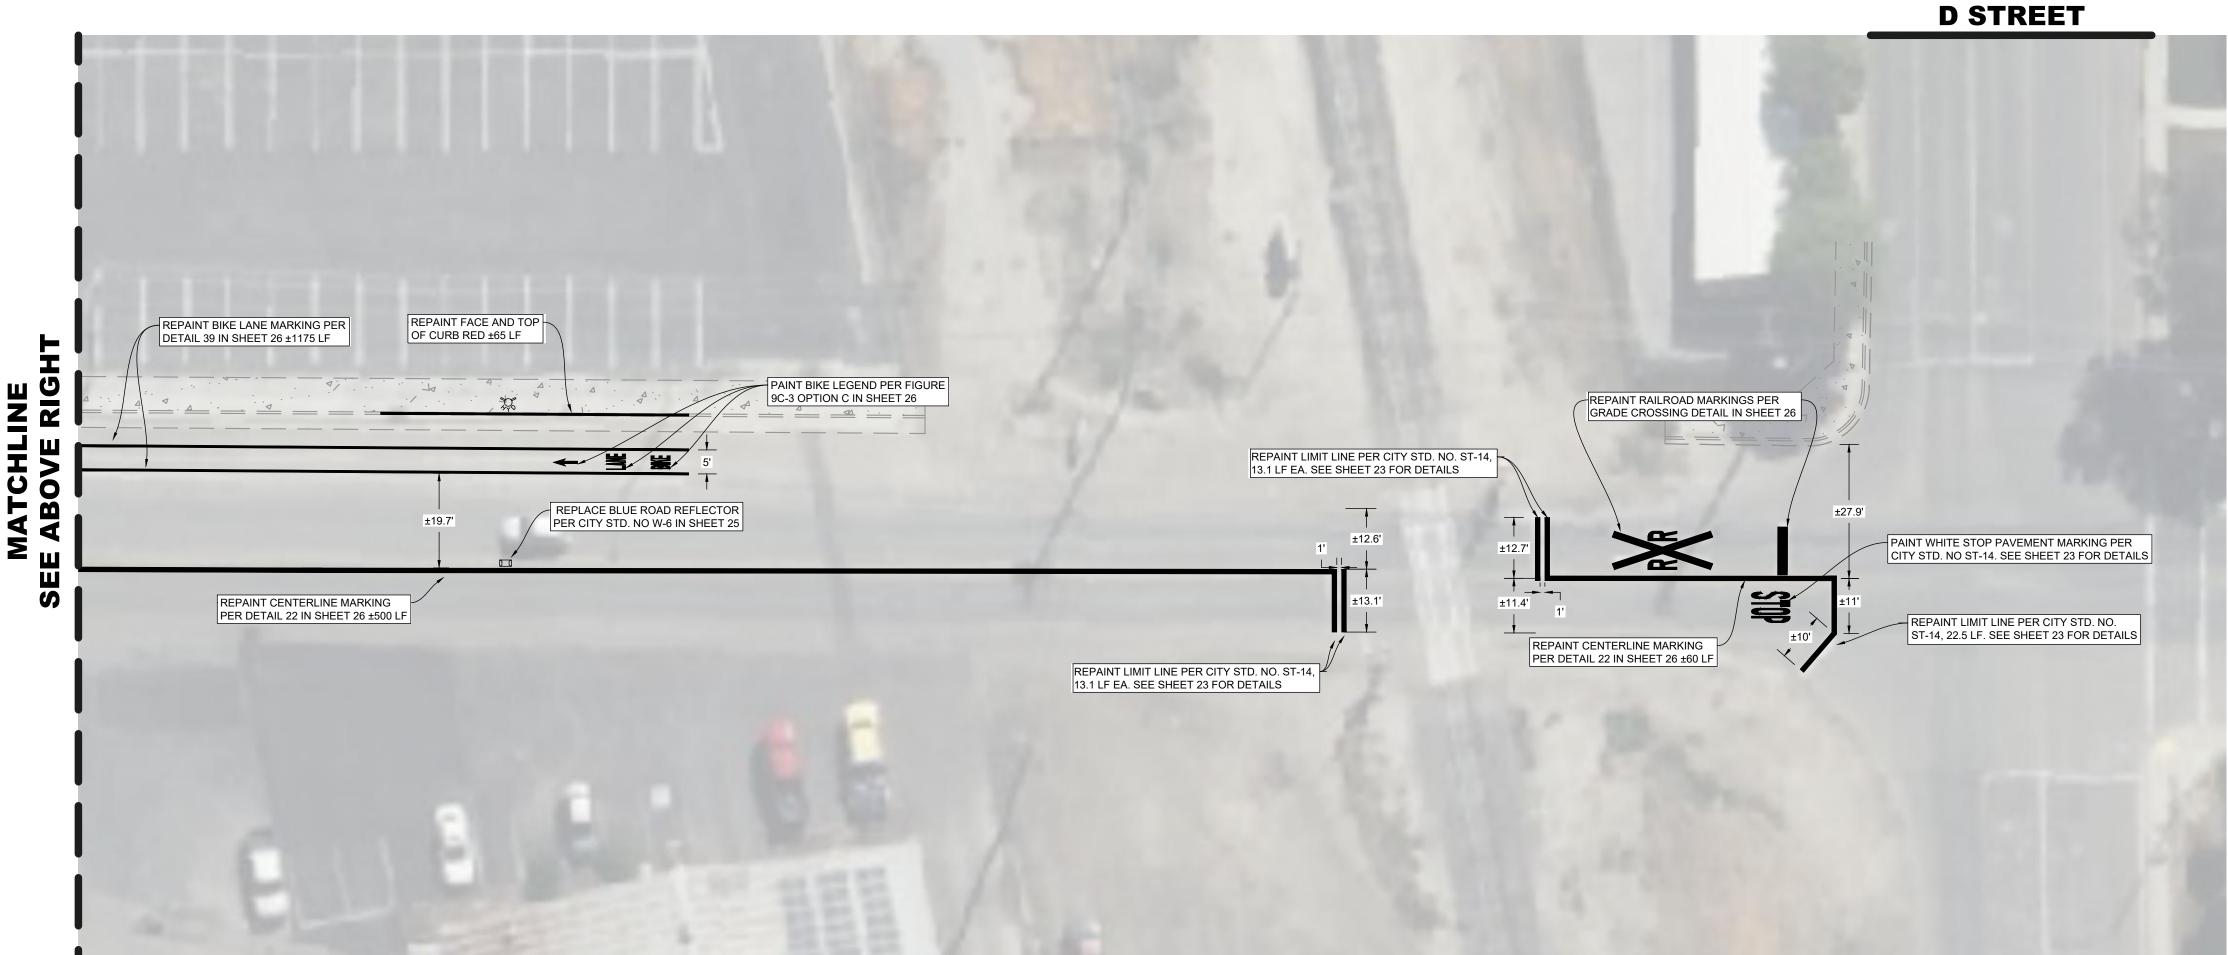

LEGEND

SEE SHEET 2

CONTRACTOR STRIPING NOTES

SEE SHEET 2

SIGNING, STRIPING & MARKING NOTES

REPAINT FACE AND TOP OF CURB WITH RED PAINT ±5 LF EA

D STREET

MAY USE R4-11 R3-7

PROPOSED SIGNS

(N.T.S.)

EXCEPT

R118 (CA)


CITY OF LEMOORE


19TH AVENUE ROADWAY





SHEET NO.

19TH AVENUE SCALE: 1" = 20'

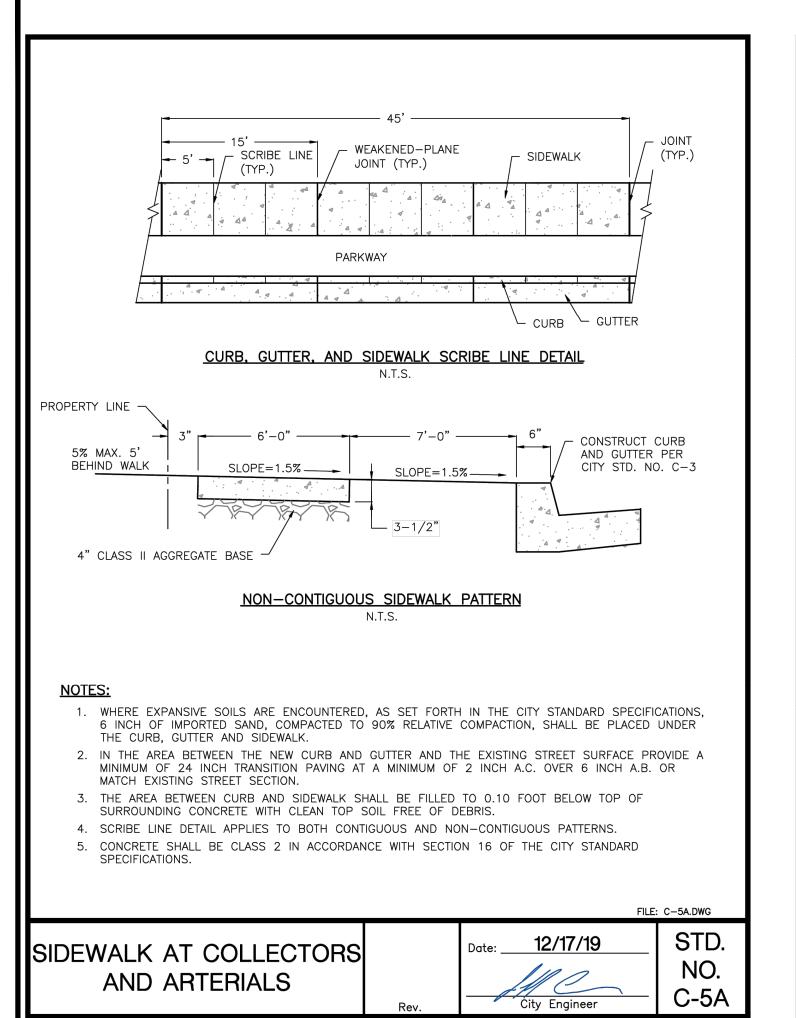

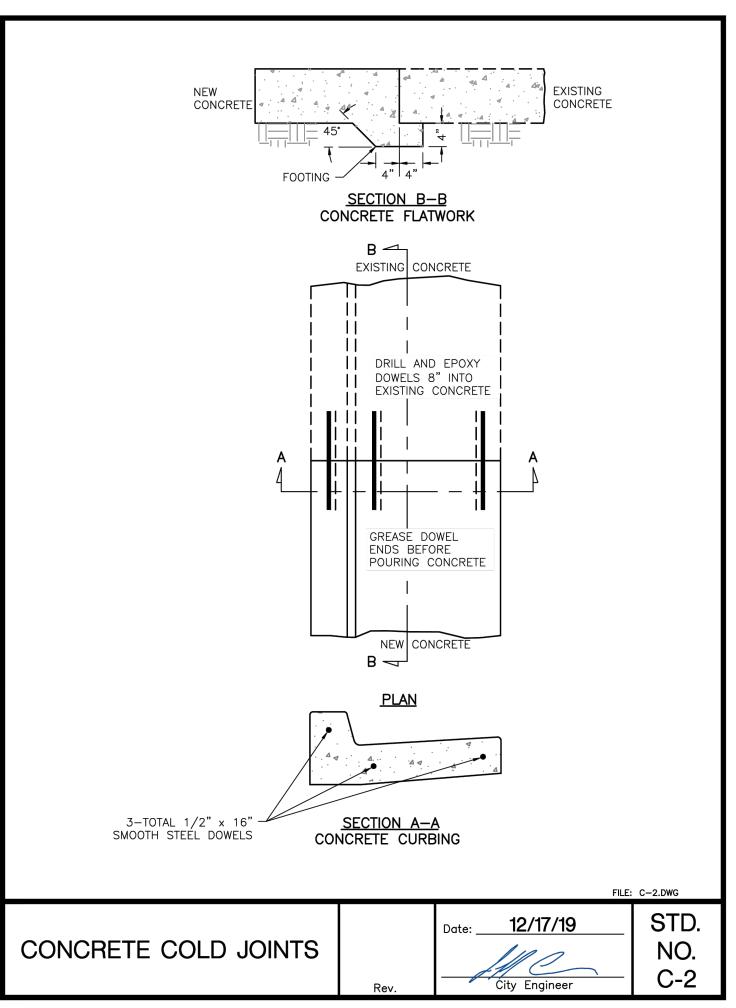

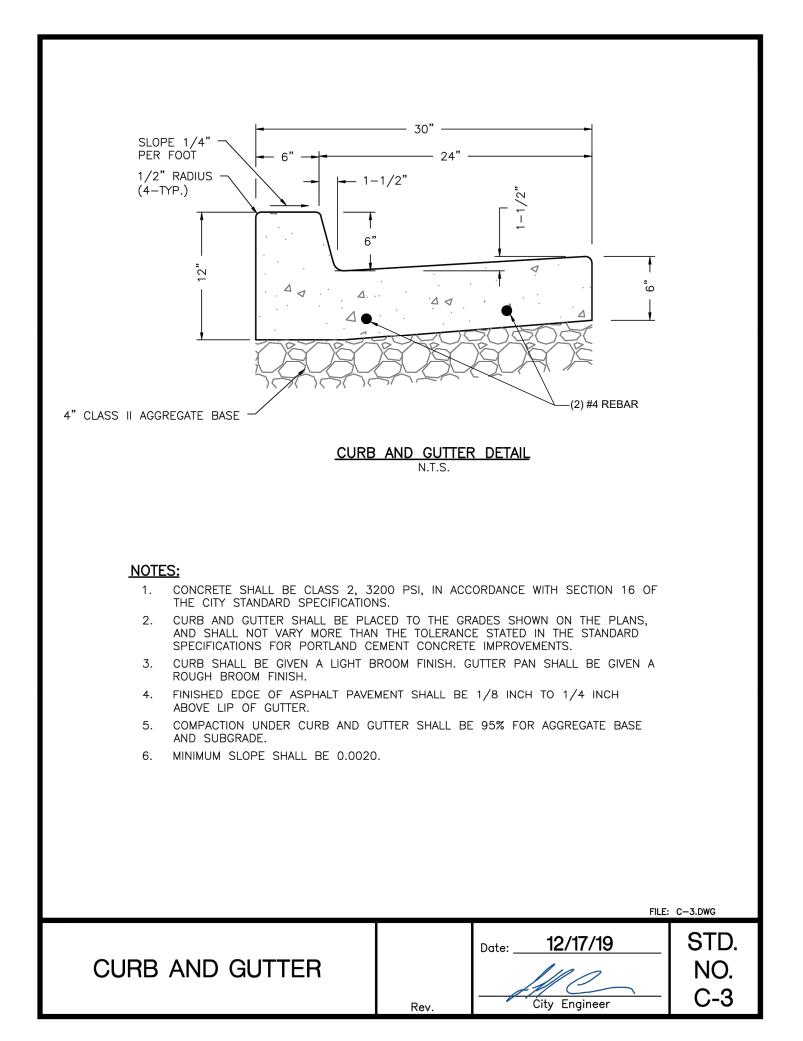

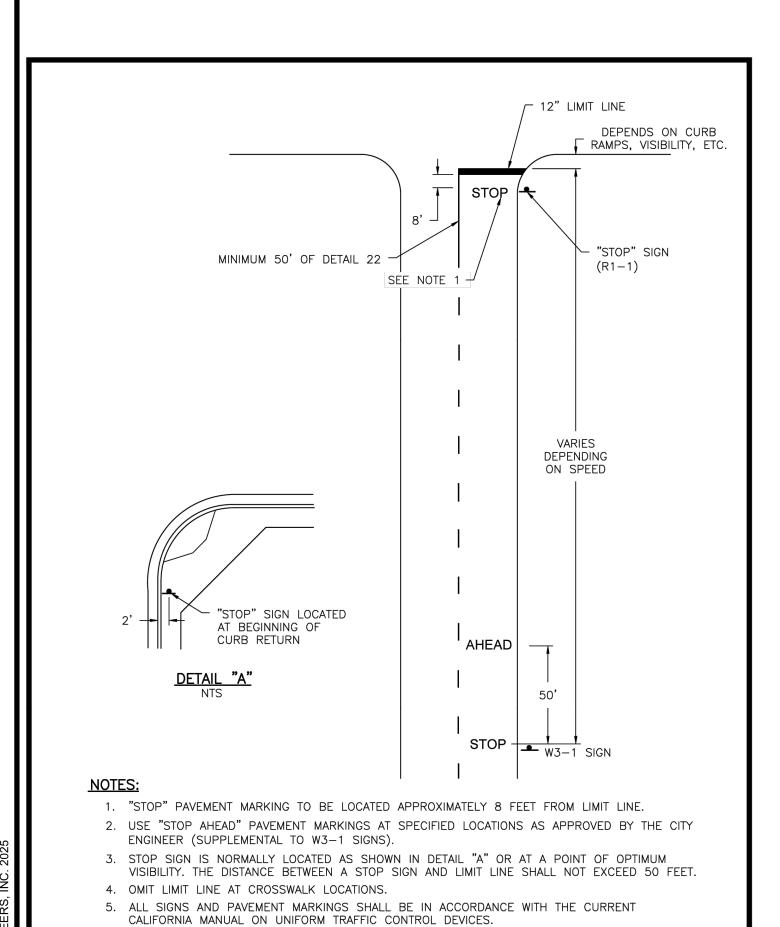



NO.


ST-14

STOP PAVEMENT

MARKINGS

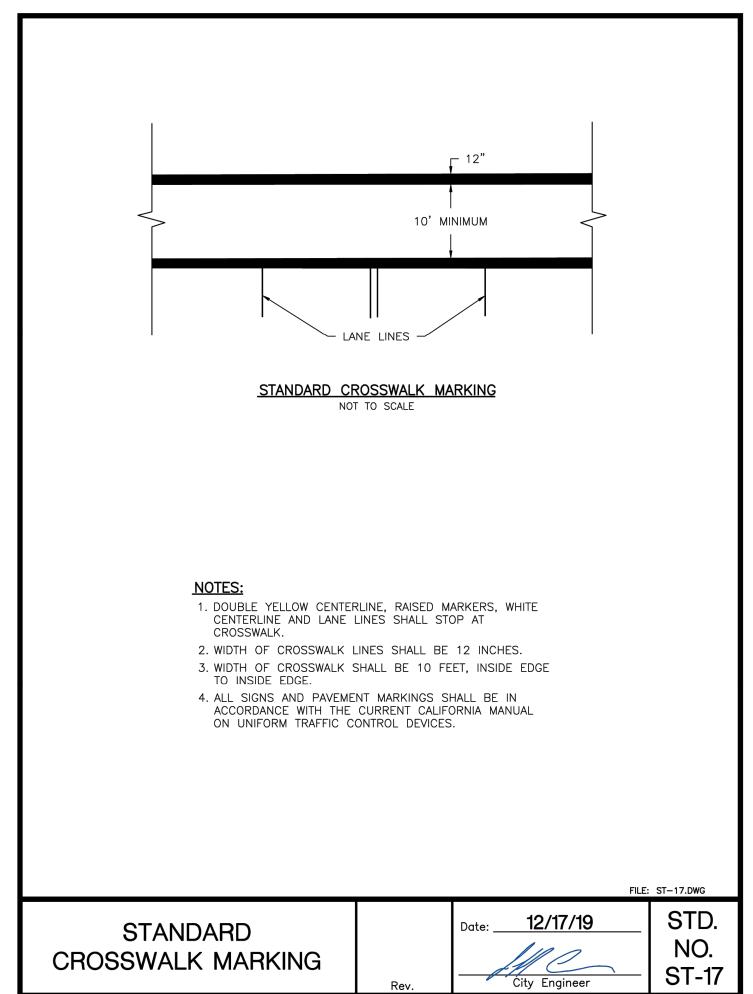


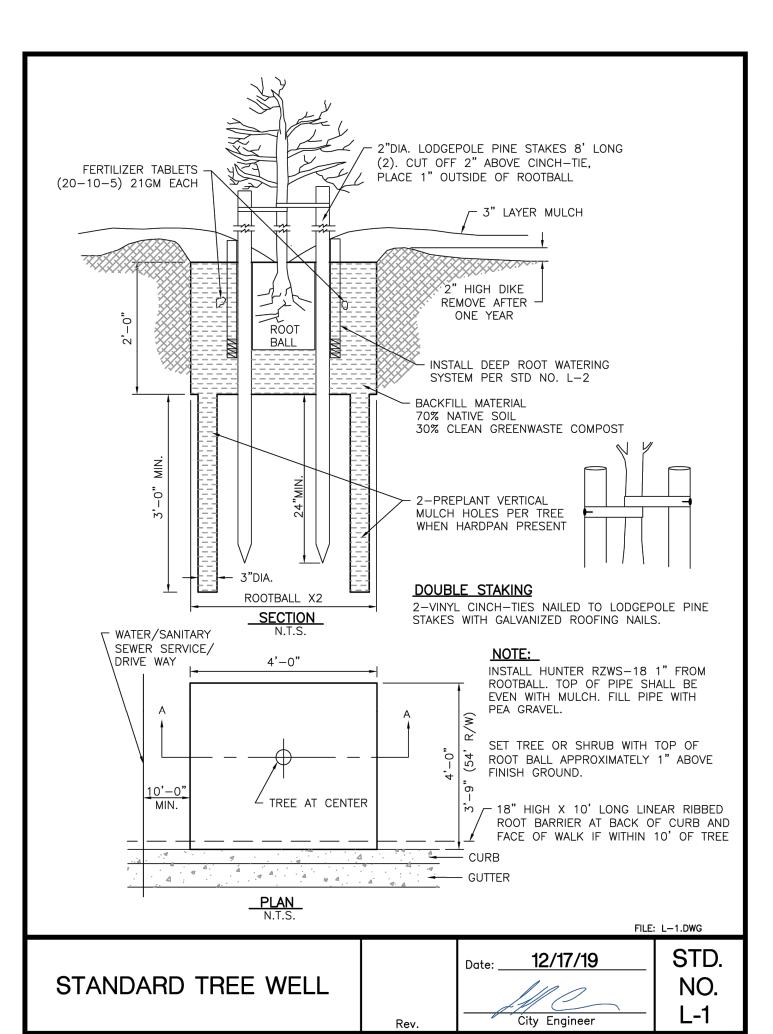

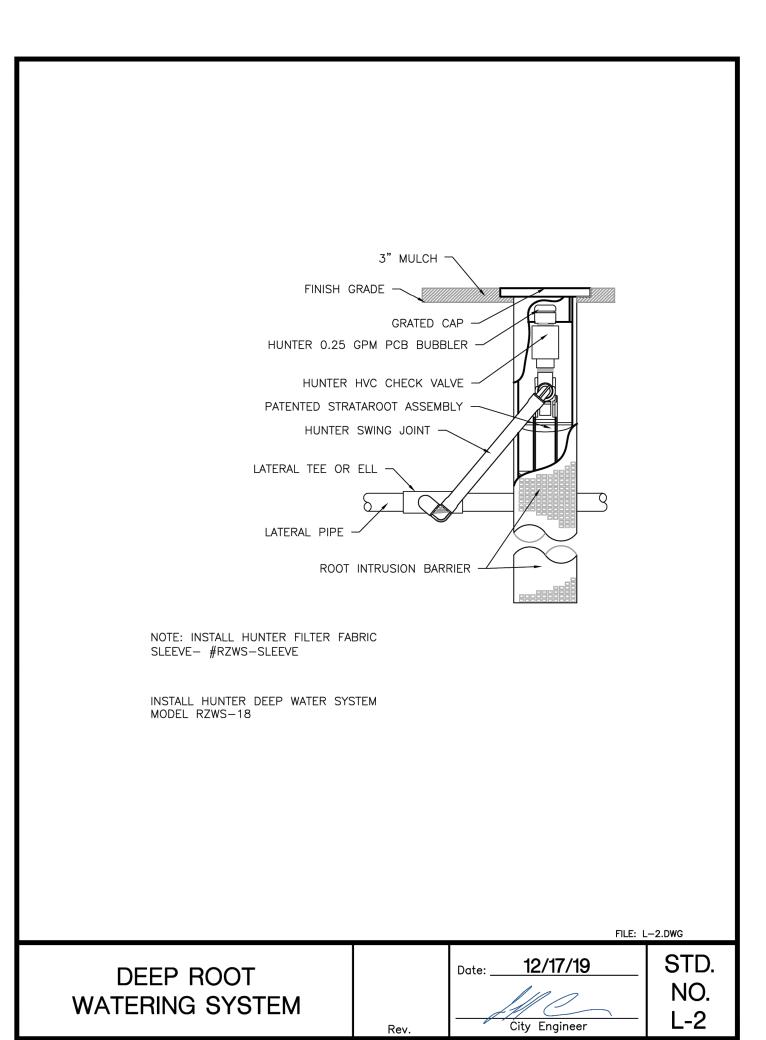





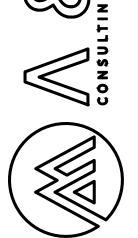

ADWAY REPAIRS

CITY OF LEMOORE

OX STREET & 19TH AVENUE ROADWAY

REVISIONS

Ö

NO: 224-036
3C: OM
: 224_036_DETAILS.DWG
E: 7/30/2025



SHEET NO.

23

05.20

- 1. ALL CONCRETE SHALL BE CLASS 3 CONCRETE UNLESS OTHERWISE SPECIFIED.
- CLASS 2 CONCRETE SHALL CONTAIN NOT LESS THAN 590 POUNDS OF PORTLAND CEMENT PER CUBIC YARD WITH 1 INCH AGGREGATE. 5 INCH MAXIMUM SLUMP. 3200 P.S.I. AT 28 DAYS.
- 3. CLASS 3 CONCRETE SHALL CONTAIN NOT LESS THAN 505 POUNDS OF PORTLAND CEMENT PER CUBIC YARD WITH 1 INCH AGGREGATE. 5 INCH MAXIMUM SLUMP. 2500 P.S.I. AT 28 DAYS.
- CLASS 4 CONCRETE SHALL CONTAIN NOT LESS THAN 420 POUNDS OF PORTLAND CEMENT PER CUBIC YARD WITH 1 INCH AGGREGATE. 5 INCH MAXIMUM SLUMP. 2500 P.S.I. AT 28 DAYS.
- WHEN MAXIMUM DAYTIME TEMPERATURE EXCEEDS 50° F. ALL NEWLY PLACED CONCRETE SHALL BE SPRAYED UNIFORMLY WITH A WHITE PIGMENTED CURING COMPOUND. CURING COMPOUND SHALL BE APPLIED AT A NOMINAL RATE OF ONE GALLON PER 150 SQUARE FEET, UNLESS OTHERWISE
- 6. ALL WORK CONSTRUCTED BY THESE STANDARDS SHALL BE IN COMPLIANCE WITH ALL CURRENT ADA REGULATIONS.
- WHEN REBAR IS USED, CONTRACTOR SHALL INSTALL WIRE TIRES SECURELY AT ALL REBAR CROSSINGS. CONCRETE CLOCK OR CHAIRS AS APPROVED BY THE CITY ENGINEER SHALL BE INSTALLED PRIOR TO CONCRETE INSTALLATION TO KEEP REBAR IN THE PROPER LOCATION.

CURBS AND GUTTERS

- ALL CURB AND GUTTER, VEE GUTTER, MEDIAN CURB AND LANDSCAPE CURB SHALL BE CLASS 3
- BARRIER TYPE CURB AND GUTTER SHALL HAVE A MINIMUM GRADIENT OF 0.20 FEET PER 100 FEET OR AS APPROVED BY THE CITY ENGINEER.
- BARRIER TYPE CURB AND GUTTER ON THE CURVE OF CUL-DE-SACS AND STREET BULBS SHALL HAVE A MINIMUM GRADIENT OF 0.35 FEET PER 100 FEET OR AS APPROVED BY THE CITY
- 4. ROLLED CURB AND GUTTER SHALL HAVE A MINIMUM GRADIENT OF 0.20 FEET PER 100 FEET OR AS APPROVED BY THE CITY ENGINEER.
- 5. ALLEY VALLEY GUTTER SHALL HAVE A MINIMUM GRADIENT OF 0.25 FEET PER 100 FEET OR AS APPROVED BY THE CITY ENGINEER.
- INTERSECTION VALLEY GUTTER SHALL HAVE A MINIMUM GRADIENT OF 0.50 FEET PER 100 FEET OR AS APPROVED BY THE CITY ENGINEER. ALL CURB AND GUTTER, VALLEY GUTTER, MEDIAN CURB AND LANDSCAPE CURB SHALL BE PLACED
- ON 4 INCH MOIST AND COMPACTED CLASS II BASE MATERIALS. 95% MINIMUM RELATIVE 8. ALL CURB AND GUTTER, VALLEY GUTTER, MEDIAN CURB AND LANDSCAPE CURB SHALL HAVE A
- LIGHT BROOM FINISH. ALL CURB AND GUTTER, VALLEY GUTTER, AND ROLLED CURB AND GUTTER SHALL HAVE WEAKENED PLANE JOINTS CONSTRUCTED AT 15 FOOT CENTERS. MEDIAN CURB AND LANDSCAPE CURB SHALL HAVE WEAKENED PLANE JOINTS CONSTRUCTED AT 20 FOOT CENTERS. WEAKENED PLANE JOINTS SHALL BE A MINIMUM OF 1-1/2 INCHES IN DEPTH AND SHALL BE FINISHED WITH A SCORING TOOL LEAVING THE EDGES ROUNDED.
- 10. ALL EXPOSED SURFACES OF CURB AND GUTTER, VALLEY GUTTER, MEDIAN CURB AND LANDSCAPE CURB SHALL NOT VARY IN EXCESS OF 0.02 FEET WHEN A 10 FOOT STRAIGHT EDGE IS PLACED ON THE SURFACE, EXCEPT AT GRADE CHANGES OR CURVES.
- 11. ALL CURB AND GUTTER AND VALLEY GUTTER SHALL BE WATER TESTED FOR FLOW.
- 12. ALL CURB AND GUTTER, VALLEY GUTTER, MEDIAN CURB AND LANDSCAPE CURB SHALL BE CURED IN ACCORDANCE WITH THE PROVISIONS IN THE GENERAL CONCRETE NOTES IN THESE IMPROVEMENT STANDARDS.

FILE: C-1.DWG

CONCRETE		Date: 12/17/19	STD.
SPECIFICATIONS		1111	NO.
SPECIFICATIONS	Rev.	City Engineer	C-1


SIDEWALKS AND RAMPS

- 1. ALL SIDEWALKS AND RAMPS SHALL BE CLASS 3 CONCRETE.
- 2. SIDEWALKS AND RAMPS SHALL BE PLACED ON 4 INCH MOIST AND COMPACTED CLASS II BASE MATERIALS. 90% RELATIVE COMPACTION UNDER SIDEWALKS. 95% RELATIVE COMPACTION UNDER RAMPS AND SIDEWALKS AT CURB RETURNS.
- 3. SIDEWALKS AND RAMPS SHALL BE STEEL TROWELED AND HAVE A LIGHT BROOM FINISH UNLESS OTHERWISE NOTED. RAMPS SHALL HAVE A HEAVY BROOM FINISH ACROSS THE SLOPE OF THE
- 4. SIDEWALKS AND RAMPS SHALL HAVE WEAKENED PLANE JOINTS CONSTRUCTED AT 15 FOOT CENTERS AND WHERE SHOWN IN THESE IMPROVEMENT STANDARDS. WEAKENED PLANE JOINTS SHALL BE A MINIMUM OF 1 INCH IN DEPTH AND SHALL BE FINISHED WITH A SCORING TOOL
- LEAVING THE EDGES ROUNDED. 5. ESTABLISHED SIDEWALK PATTERN IN BLOCK SHALL BE MATCHED.
- 6. SPECIAL SIDEWALK DESIGNS AND MATERIALS SHALL BE SUBJECT TO APPROVAL BY THE CITY
- 7. SIDEWALK INSTALLED IN INFILL OR EXISTING AREAS SHALL BE SUBJECT TO THE APPROVAL OF
- THE CITY ENGINEER. 8. ALL SIDEWALKS AND RAMPS SHALL BE CURED IN ACCORDANCE WITH THE PROVISIONS IN THE
- GENERAL CONCRETE NOTES OF THESE IMPROVEMENT STANDARDS. 9. DETECTABLE WARNING SURFACES SHALL BE INSTALLED PER THESE IMPROVEMENT STANDARDS AND
- AS REQUIRED BY THE CITY ENGINEER. 10. ALL SIDEWALK JOINTS SHALL NOT EXCEED 1/2 INCH WIDTHS.


DRIVE APPROACHES

- 1. ALL DRIVE APPROACHES SHALL BE CLASS 3 CONCRETE UNLESS OTHERWISE NOTED.
- SINGLE FAMILY RESIDENTIAL DRIVE APPROACHES SHALL BE PLACED ON 6 INCH MOIST AND COMPACTED BASE MATERIALS. 95% RELATIVE COMPACTION.
- MULTI-FAMILY RESIDENTIAL, OFFICE AND COMMERCIAL DRIVE APPROACHES SHALL BE PLACED ON 6 INCH MOIST AND COMPACTED CLASS II BASE MATERIALS. 95% RELATIVE COMPACTION.
- 4. DRIVE APPROACHES SHALL BE STEEL TROWELED AND HAVE A LIGHT BROOM FINISH. 5. DRIVE APPROACHES SHALL HAVE A WEAKENED PLANE JOINT CONSTRUCTED AT EACH EDGE AND AT THE CENTERLINE. WEAKENED PLANE JOINTS SHALL BE A MINIMUM OF 1-1/2 INCH IN DEPTH
- AND SHALL BE FINISHED WITH A SCORING TOOL LEAVING THE EDGES ROUNDED. 6. NOT MORE THAN 60% OF PROPERTY FRONTAGE SHALL BE USED AS DRIVE APPROACH.
- DRIVE APPROACHES ON STATE ROUTES ARE SUBJECT TO APPROVAL BY CALTRANS. ALL DRIVE APPROACHES SHALL BE CURED IN ACCORDANCE WITH THE PROVISIONS IN THE
- GENERAL CONCRETE NOTES OF THESE IMPROVEMENT STANDARDS.
- ALL EXPOSED SURFACES OF DRIVE APPROACHES AND FLOW LINES SHALL NOT VARY IN EXCESS OF 0.02 FEET WHEN A 10 FOOT STRAIGHT EDGE IS PLACED ON THE SURFACE, EXCEPT AT GRADE CHANGES OR CURVES.

		FILE:	: C-1A.DWG
CONCRETE SPECIFICATIONS	Rev.	Date: 12/17/19 City Engineer	STD. NO. C-1A

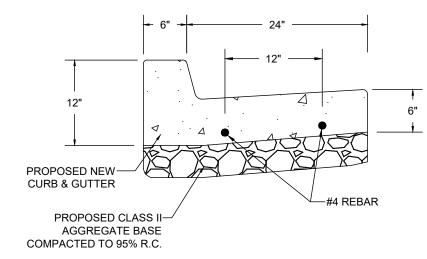

SIDE VIEW

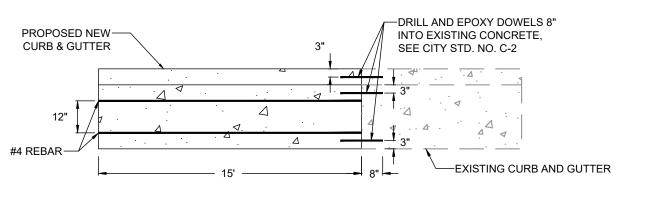



PLAN VIEW


NOTES:


- 1. ALL EXISTING CURB AND GUTTER AREAS TO BE REMOVED SHALL BE SAWCUT ALONG THE NEAREST SCORELINE OR WEAKEST PLANE JOINT AND REPLACED.
- 2. REFER TO CITY STANDARDS C-1, C-2, C-3, AND C-5A FOR ADDITIONAL INFORMATION REGARDING CONCRETE CURB AND GUTTER SPECIFICATIONS
- 3. A TOTAL OF THREE (3) SMOOTH STEEL DOWELS (1/2" x 16") SHALL BE DRILLED WHEN PROPOSED NEW CURB & GUTTER REACHES EXISTING CURB & GUTTER. SEE CITY STD. NO. C-2.
- 4. DOWEL ENDS SHALL BE GREASED BEFORE CONCRETE IS POURED.
- 5. #4 REBAR SHALL BE PLACED 3" FROM DOWEL END WHEN EXISTING CURB & GUTTER IS ENCOUNTERED.

CURB & GUTTER REINFORCEMENT DETAIL (N.T.S.)

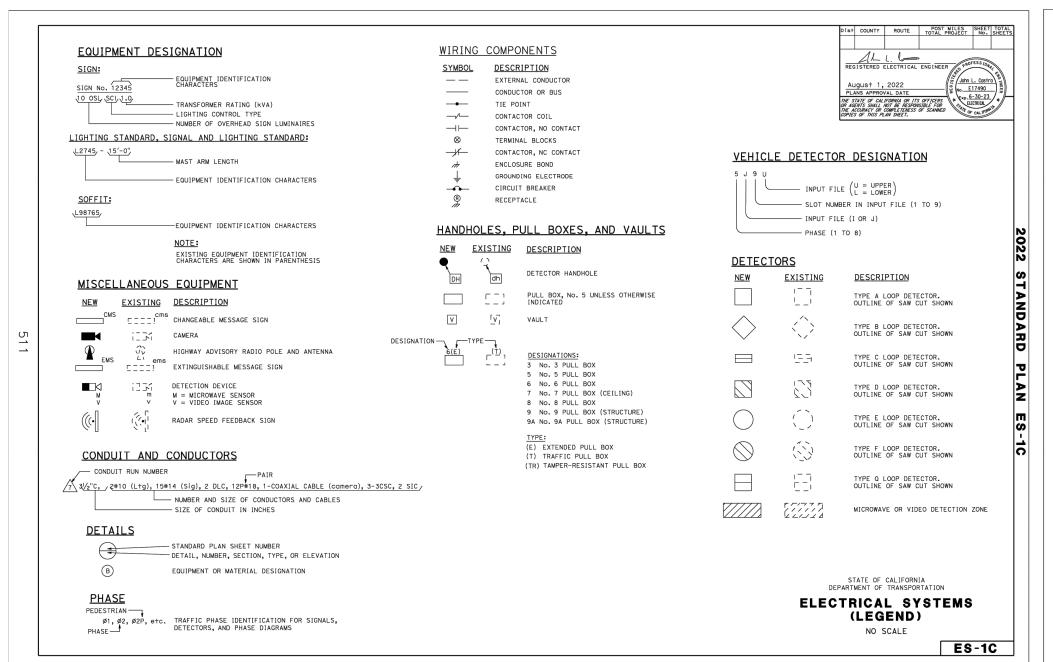


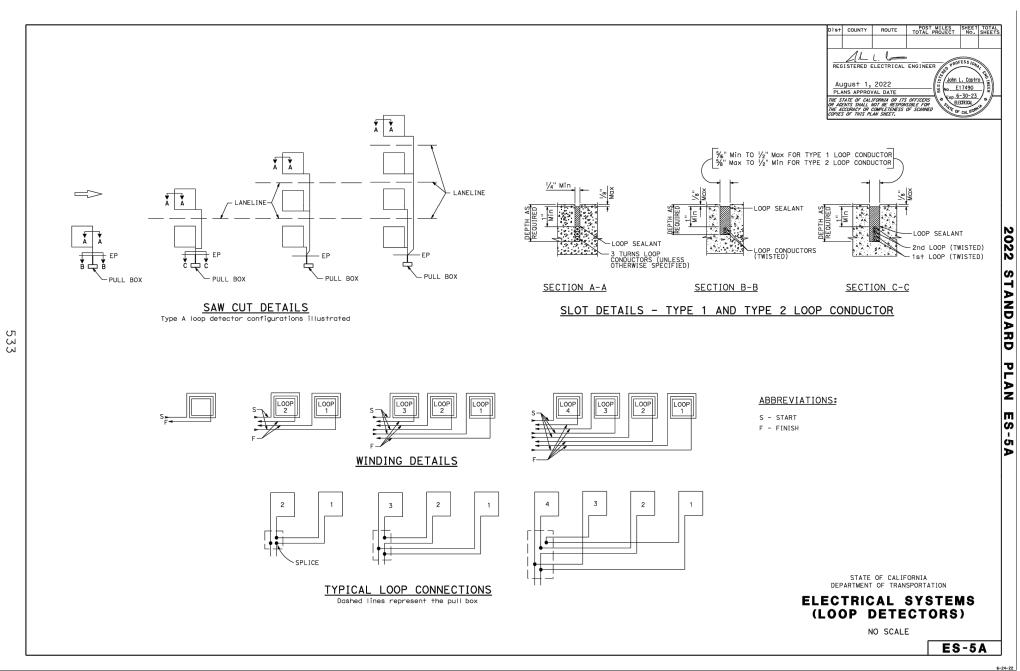

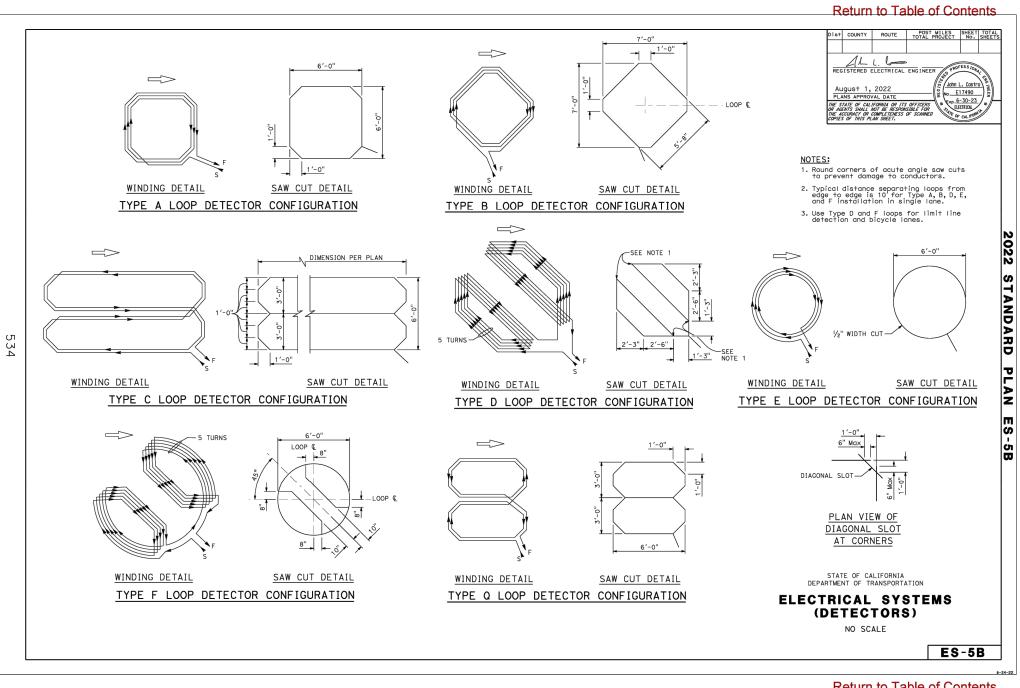

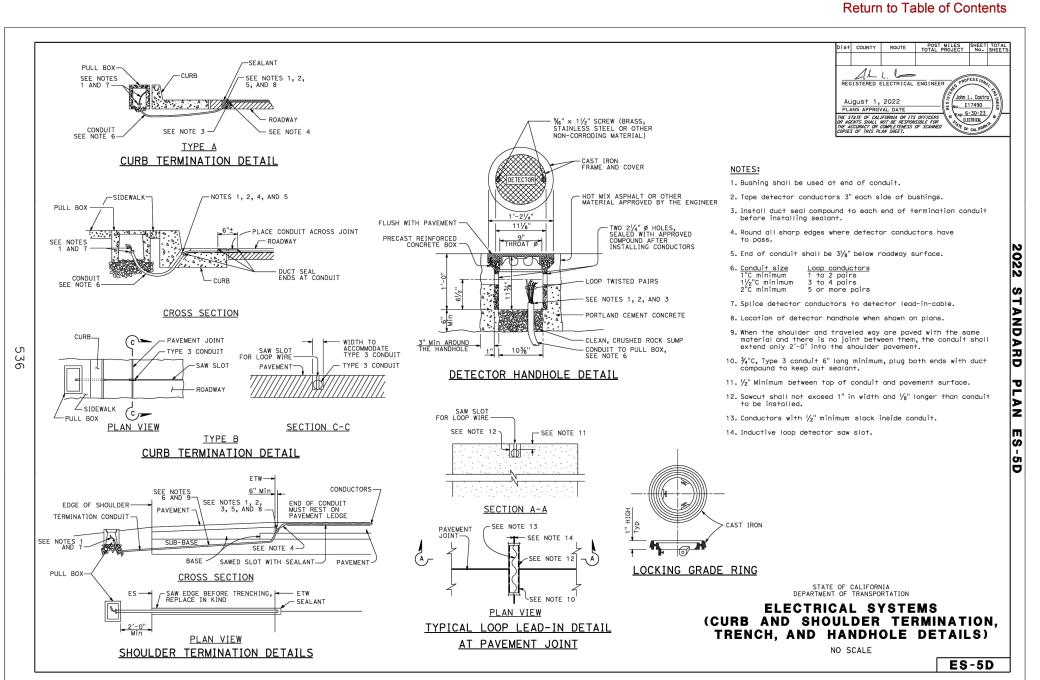

Return to Table of Contents

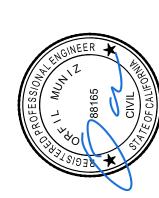

 Δ ORE

CITY 19TH S XO


Revised March 27, 2020

California MUTCD 2014 Edition


(FHWA's MUTCD 2009 Edition, including Revisions 1,2, &3, as amended for use in California)

Figure 9C-102 (CA). Examples of Bicycle Lane Treatment Where Vehicle Parking is Prohibited/Permitted

WHERE VEHICLE PARKING IS PROHIBITED

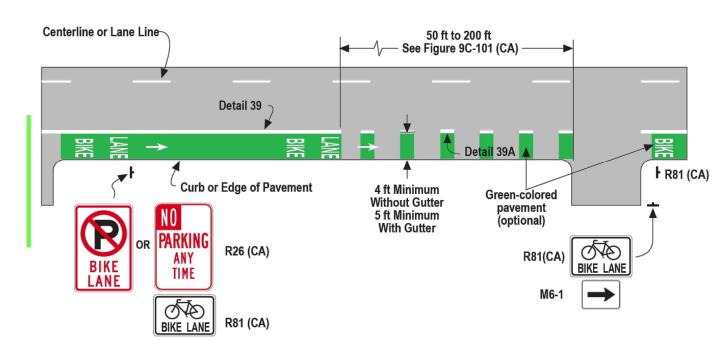


WHERE VEHICLE PARKING IS PERMITTED

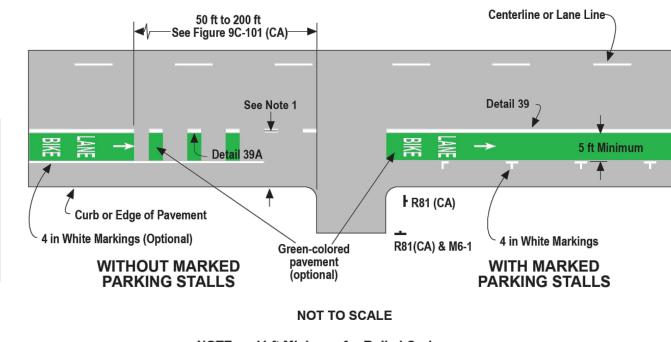


NOTE: 11 ft Minimum for Rolled Curb 12 ft Minimum for Vertical Curb

Chapter 9C - Markings Part 9 – Traffic Control for Bicycle Facilities Revised December 7, 2023

Page 1426

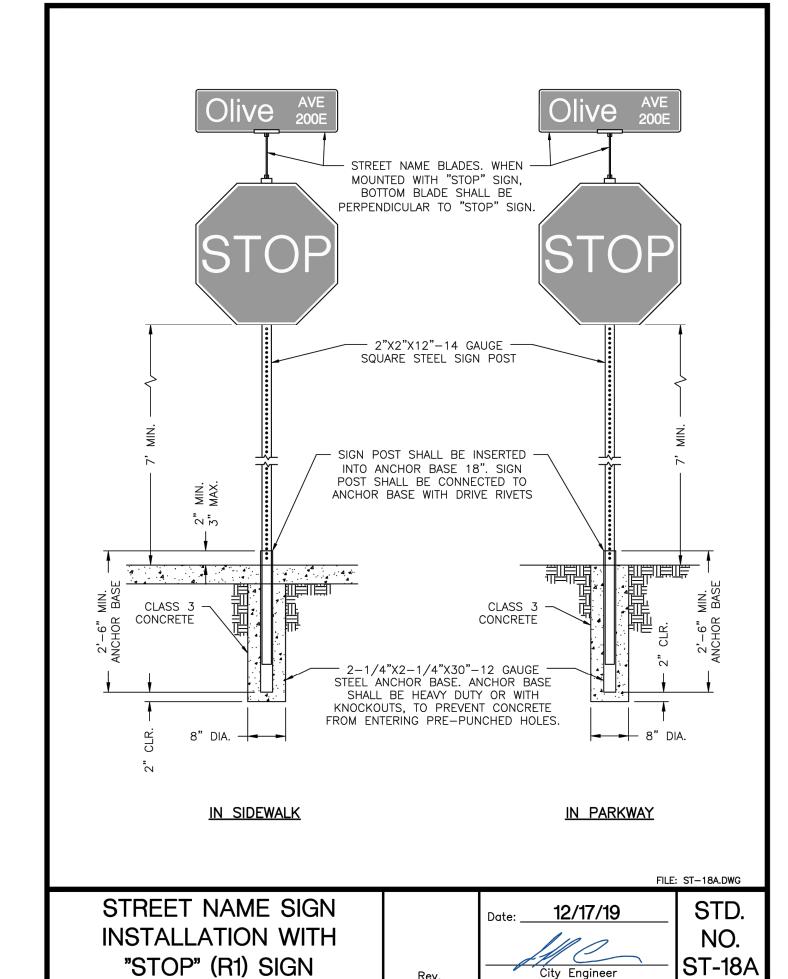

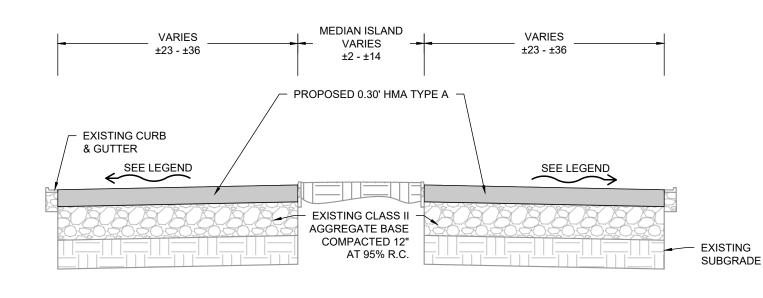


Chapter 9C – Markings

Part 9 – Traffic Control for Bicycle Facilities


1. NEW HMA SHALL CONFORM TO THE EXISTING PAVEMENT CROSS SLOPE.


DETAIL C - MEDIAN ISLAND SECTION N.T.S.

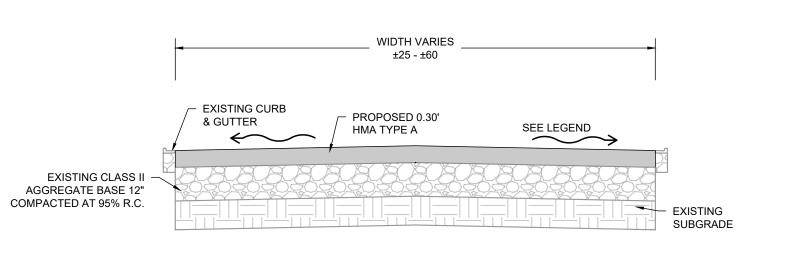

1. NEW HMA SHALL CONFORM TO THE EXISTING PAVEMENT CROSS SLOPE.

DETAIL D - TYPICAL SECTION N.T.S.

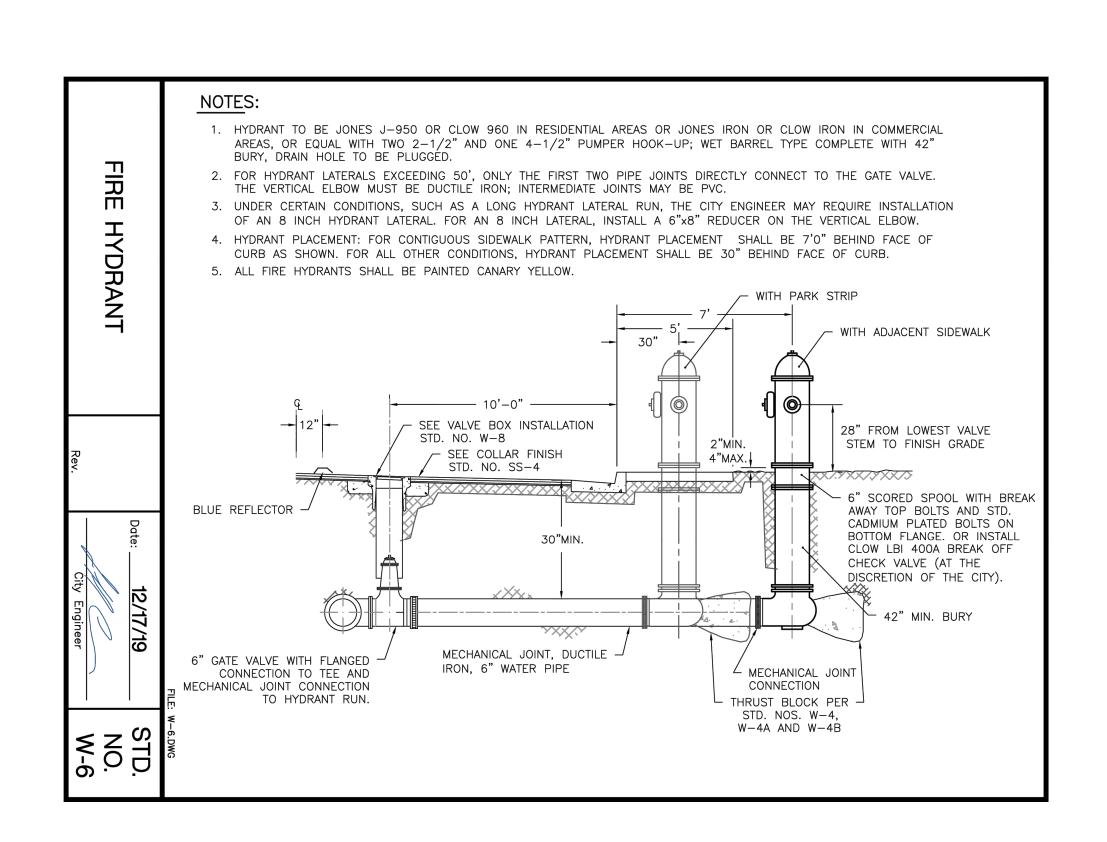

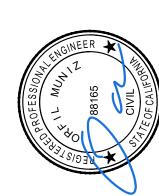

REPAIR


ENGINEERING PLANS FOR:

7 OF LEMOORE

1 AVENUE ROADWAY F ETAIL CITY 19TH

STRI XO




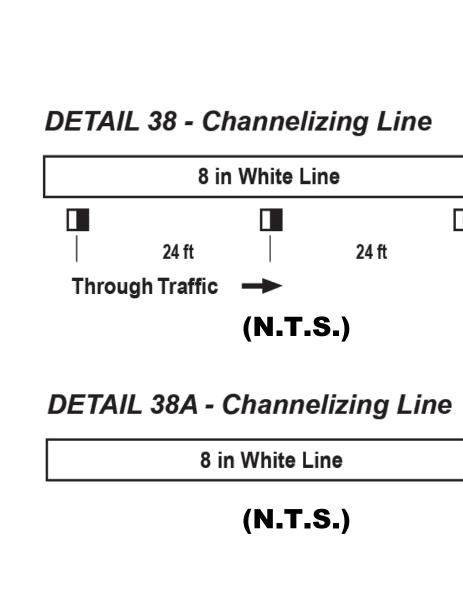


DETAIL 39 - Bike Lane Line

6 in White Line (N.T.S.)

DETAIL 39A - Bike Lane Intersection Line

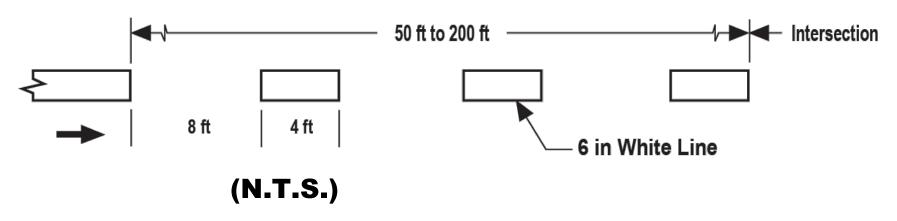

DETAIL 22

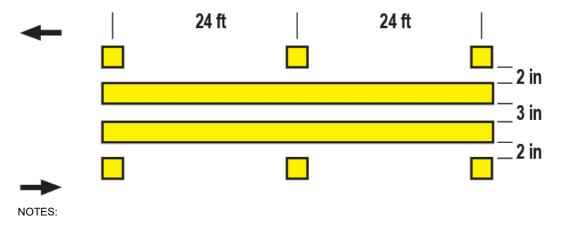

- 1. PAVEMENT MARKERS SHOWN OFF IN DETAIL 22 MAY BE PLACED ON THE LINE.
- 2. IF THE MATERIAL USED FOR THE CENTERLINE MARKING IS A PAINT, A 3 IN BLACK LINE SHALL BE PLACED BETWEEN THE YELLOW LINES ON STATE HIGHWAYS AND MAY BE PLACED ON STREETS AND HIGHWAYS UNDER LOCAL JURISDICTION,

(N.T.S.)


DETAIL 32 POLICY Two-way left-turn lane pattern for use on streets and highways. See Note 2.

- 1. PAVEMENT MARKERS SHOWN OFF THE SOLID LINE IN DETAIL 32 MAY BE PLACED ON THE LINE.
- 2. IF THE MATERIAL USED FOR THE CENTERLINE MARKING IS A PAINT, A 3 IN BLACK LINE SHALL BE PLACED BETWEEN THE YELLOW LINES ON STATE HIGHWAYS AND MAY BE PLACED ON STREETS AND HIGHWAYS UNDER LOCAL JURISDICTION,

(N.T.S.)

Width may vary according to lane width 6 ft 20 ft RAILROAD CROSSING SYMBOL **GRADE CROSSING MARKINGS DETAIL**

(N.T.S.)

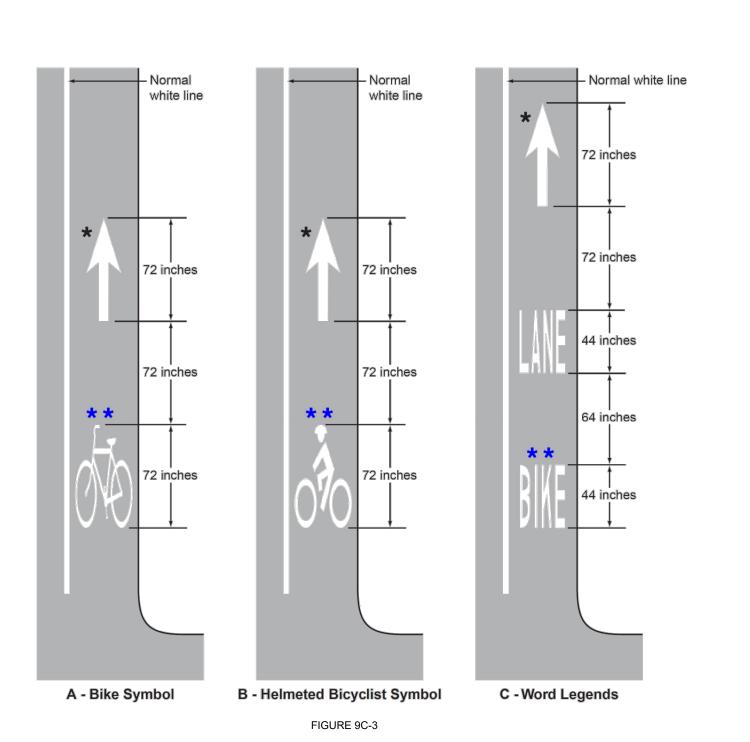

BIKE LANE MARKINGS DETAIL OPTIONS (N.T.S.)

optional at other locations

** Required on far side of each intersection,

Optional


LEGEND

4 to 6 in Yellow (for local agencies) 6 in Yellow (on State Highway System)

■ Two-Way Yellow Retroreflective Markers Non-Retroreflective Yellow Markers


Direction of Travel

4 to 6 in White (for local agencies)
6 in White (on State Highway System)

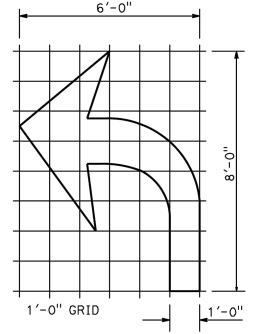



 $A=15 f+^2$ TYPE Ⅳ (L) ARROW Type Ⅳ (R) arrow, use mirror image.


(N.T.S.)

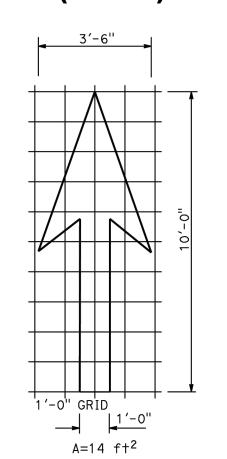


TYPE I 10'-0" ARROW (N.T.S.)

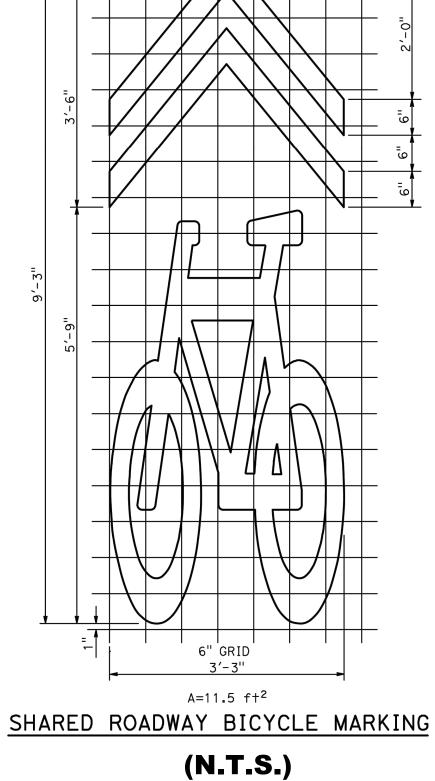

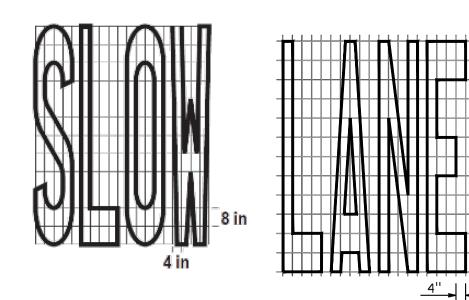

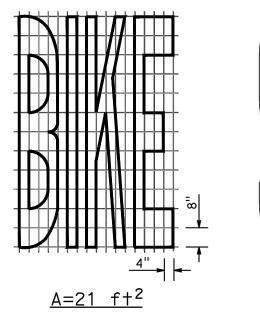

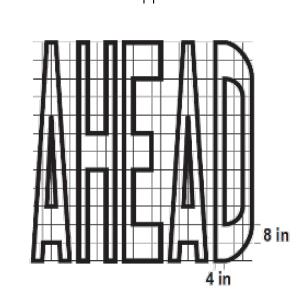


1. ALL LETTERS AND NUMBERS SHOULD BE IN CONFORMANCE WITH THE STANDARD ALPHABETS FOR HIGHWAY SIGNS AND PAVEMENT MARKINGS APPROVED BY DEPARTMENT OF TRANSPORTATION.

2. THE DESIGN DETAILS FOR VARIOUS WORDS ARE ALSO SHOWN IN DEPARTMENT OF TRANSPORTATION'S

3. CONTRACTOR MAY USE CITY STENCIL

PAVEMENT MARKING WORDS DETAIL (N.T.S.)

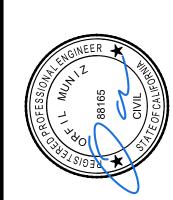

CITY OF LEMOORE

19TH AVENUE ROADWAY REPAIRS & MARKING

